

December 3, 2021

City of Arvada Attn: Jeremiah Bebo, Planner II Community and Economic Development 8101 Ralston Rd. Arvada, CO 80002 Email: <u>JBebo@Arvada.org</u>

RE: 6800 Kilmer RV Storage - Site Plan and Minor Plat Submittal

Dear Mr. Bebo,

We are submitting for a site plan and minor plat for the RV storage business proposed at 6800 Kilmer (please see the site plan graphic on the second page). The site is 14 acres and is zoned IL (Industrial, Light). While the concept plan for the Pre-Application meeting included self-storage buildings, the plans have been re-designed to exclude them. Rather the site consist of 556 RV storage spaces and a 1,890 square foot office-building.

As discussed, the developer is open to a discussion regarding dedicating all of land within the 100-year floodplain as well as the northwesterly area where the Ralston Creek Trail is located. However, in furthering those discussion, we would like to ensure that all site calculations will be based on the gross land area prior to the net area that will result from the land dedication. Additionally, we request that required setbacks be established from the existing property line versus the future property line that would be created from the land dedication. Considering the land to the north would not be developed, it is our position that the intent of the setback would be maintained. Essentially, we would like to ensure that there are no losses of RV storage spots with the land dedication.

Also, as discussed due to the existing 20-foot wide Consolidated Mutual Waterline easement directly adjacent to the southerly property boundary, a fence is not permitted along the property line nor within this easement. Only small shrubs are allowed in this easement as well. Thus, the fence is designed to be just north of the easement. It is our impression that locating the landscaping on the outside of the fence (south side) would provide a better aesthetic buffer from adjacent properties versus placing the landscaping on the inside of the property.


Thank you in advance for your facilitation of the review process. We look forward to receiving all of the City referral comments. Please do not hesitate to contact me via phone or email if you would like to discuss any aspect of the application.

Sincerely, Norris Design

Kristin Dean

Kristin Dean, AICP Senior Associate – Planner



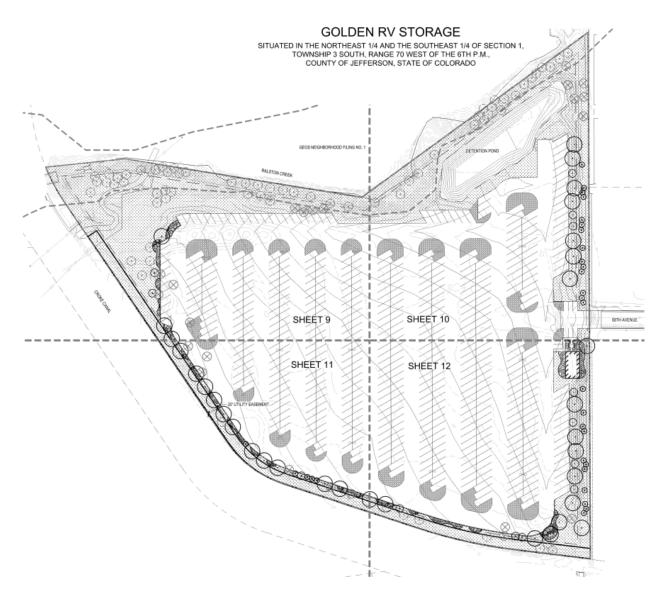



6800 Kilmer St. RV Storage Response to Pre-Application Comments Application Number: PA2021-0111

Dear Mr. Bebo:

Thank you for the comments on the 6800 Kilmer St RV and Self-Storage Pre-Application Review which we received on July 27, 2021. We have reviewed all the comments and have addressed them herein.

Please feel free to contact me directly should you have any other comments, questions and/or special requests for additional information. We look forward to continuing to work with you and your colleagues at the City of Arvada.

Sincerely, Norris Design

Kristin Dean

Kristin Dean, AICP Senior Associate - Planner



FLOODPLAIN STANDARD-Andrew Stewart-undefined- astewart@arvada.org

It appears that your plan is to encroach in the Ralston Creek's floodway. No improvements will be allowed within the floodway that result in any increase to the flood levels during the occurrence of the base flood discharge. Please submit your floodplain analysis to be reviewed.
 Response: Plan has been updated to avoid Ralston Creek floodway encroachment.

PLANNER-PREAPP-Jeremiah Bebo-720-898-7438- jbebo@arvada.org

- IL (Industrial, Light) zoning. *Response: Noted*
- 20' front setbacks (taken from the east) which includes parking. 5' side and rear setbacks. 50% maximum lot coverage (buildings).
 Response: Noted
- 35% maximum outdoor storage allowed. Response: The area designated for RV storage is 609,840 square feet or 31% of the gross site area.
- LDC 3-1-3-8-D-1c: Use shall be located behind the principal building; configuration does meet the requirement. this configuration meets that requirement. Type C bufferyard is required along the south, west, and north. Response: Self-storage buildings are no longer proposed. Only a small office will be located at the entry to the site. A Type C Bufferyard is included around the south, west, and north perimeters. Due to the existing Consolidated Mutual Water Line easement being directly adjacent to the south property line, a fence cannot be located within this easement. Instead, the fence is proposed to the north of the easement. The landscaping is proposed to be on the outside (south side) rather than inside the fence in order to provide a more aesthetic buffer from neighboring properties.
- Self-Storage must meet LDC 3-1-3-7-H (limited use standards) and LDC 5-1-2-8 for architecture. *Response: There are no self-storage buildings proposed. The only building is a small office.*
- Storage building cannot be located in the buffer, but the outermost walls may be used and incorporated into the design of the wall required for the buffer.
 Response: There are no self-storage buildings proposed with this plan.
- Gravel surface parking lot can be explored although Fire is most likely going to need their access road paved. Response: Gravel surface parking lot approved by Arvada Fire, per meeting on 10/25. No additional pavement for fire lanes is required, as the site plan has been revised to eliminate 2 of the 3 buildings, and only the office building remains.
- It has been raised that the Consolidated Mutual Water Line may not be active any longer which would be helpful for tree planting and other issues. Please reach out to them to verify this and understand their easement vacation process if applicable.
 Response: Consolidated Mutual Water Line is active, Plans have been updated to avoid work in easement.
- A minor subdivision plat will be required as the land is not platted. **Response:** A minor subdivision plat is being prepared to plat the parcel.
- A Site Plan and Minor Subdivision will be reviewed administratively. Please note that the City will not be able to

provide approvals until the State has approved the various permits/entitlements needed per Engineering.

Response: Noted

ENG-DEVEL-PREAPP-Kyle Gillitzer-(720)-898-7435- kgillitzer@arvada.org

- 1.Water: There is a 10" AC Line on W 68th Ave at entrance to the site. No excavating/grading may occur at the site without documentation/permits from the Colorado Department of Public Health and Environment for waste site reclamation and remediation. This includes all utility line work, pond excavating/grading, etc.
 Response: Noted
- 2.Sanitary: There is an 8" PVC line on the north west corner of the site. The city will take no responsibility of any utility line placed within this site due to its former waste site nature. All utility lines will be private and privately maintained.

Response: Noted. Sanitary sewer connection for the site will be made via rights-of-way 68th and Joyce to existing sanitary sewer infrastructure north/east of the Site.

- 3.Storm:Water Quality and detention will be required if ground disturbance is 1 acre or larger. **Response:** WQ/Detention pond is proposed at the north end of the site. All grading has been designed to promote overland flow to the pond to avoid utility trenching in existing landfill material.
- For projects 1 acre or larger, an O&M Manual is required for all water quality/detention facilities. *Response: Noted an O&M Manual will be included with the final drainage report.*
- Owner/developer shall obtain a State General Permit for Stormwater Discharges Associated with Construction Activities from the Colorado Department of Public Health and Environment (CDPHE), Water Quality Control Division, prior to clearing, grading, or excavating on the site.
 Response: Noted
- All onsite drainage facilities should be identified as privately owned and maintained and should be located within a drainage easement.
 Response: Noted WQ/Detention Pond is the only on-site drainage facility, and will be located within an easement once the final shape/size/location of the pond is determined.
- Foundation drains / private underdrains will need to be completely separate from public utilities. *Response: Noted no foundation drains or private underdrains are proposed.*
- Your proposed detention pond is within a FEMA floodplain, it must be moved. The north side of the property also lies within federally designated wetlands. Any work in a wetland will require a 404 permit from the US Army Corps of Engineers.

Response: Detention Pond has been moved to avoid floodplain.

- Public Improvements: All City right of way adjacent to development property is required to be brought up to current City of Arvada standards.
 Response: Noted – No public rights-of-way are adjacent to the development property.
- Bring entire site in to ADA compliance an ADA accessible route to and from the building and the right-of-way will need to be provided
 Response: Noted – ADA route to and from the building has been provided.

1101 Bannock Street | Denver, CO 80204



 Ralston Creek's channel within your property is degrading and eroding allowing landfill refuse to litter into the stream. The stream channel will need to be stabilized. This work must be coordinated with Mile High Flood District and under CDPHE guidance as a former waste refuse site.
 Response: Coordination with Mile High Flood District initiated on 11/18 and will continue through the

Response: Coordination with Mile High Flood District initiated on 11/18 and will continue through the design phase of the project.

• Traffic:

Complete the Base Assumptions Form and submit to your review engineer. At a minimum, a trip generation letter will be required. A full Traffic Impact Analysis (TIA) shall be required with applications for development review and approval when the trip generation during any peak hour is expected to exceed more than 100 trips during any one-hour peak or to exceed 250 trips per day.

Response: Base assumptions form was completed and submitted, a trip generation letter has been prepared and is included with this submittal.

• 6.Grading:

A Site Disturbance Permit will be required if the ground disturbance is greater than 10,000 sf. https://arvada.org/business/permits-and-applications/site-disturbance-permit **Response**: **Noted**

• Retaining walls more than 4' tall (measured from top of wall to bottom of footer) require a special permit through the building department.

Response: Noted - No retaining walls are proposed at this time.

- Maximum slope in a landscape area is 4:1. *Response*: *Noted*
- All off site grading/construction of any kind will require signed permission from all applicable property owners. *Response*: *Noted*
- LOC/Cash escrow:

Developers are required to provide an escrow in the amount of 100% of the estimated cost of public improvements via cash or letter of credit. When the developer successfully completes the public improvements and warranty is initiated, the City will retain 20% of the certified construction costs and release the remaining 80% of the escrow back to the developer. The City will retain 20% of the certified construction cost of public improvements to ensure that the public improvement meets the City standards through the 2- year warranty period. *Response: Noted, thank you.*

- Applicants shall verify with Arvada Fire Protection District if fire access and circulation is sufficient and if the fire hydrant requirements have been met.
 Response: Noted A meeting with Arvada fire was held and it was determined that the site plan circulation was sufficient for firefighting needs at the office building.
- Standard checklists for CDs, Drainage Report, Utility Report, and Traffic Report must be followed. Checklists can be found on the Arvada website. https://arvada.org/business/permits-and- applications/documents-and-downloads *Response*: *Noted*

SITE DEV. STANDARD-Sandra McDonald-720-898-7811- smcdonald@arvada.org

• No excavation - only 3 feet of fill

Response: Grading has been designed to eliminate the need for excavation to the greatest extent possible, to avoid disturbing existing landfill materials.

- Compaction may vary throughout site, monitor for potential settlement *Response*: *Noted*
- Runoff control of impervious areas **Response:** Noted – A WQ/Detention Pond has been provided at the north end of the site to treat and detain runoff from the Site.
- Infiltration is not recommended *Response*: *Noted*
- Protect methane wellheads *Response*: *Noted*
- Limit landscaping where roots could affect landfill cover *Response*: *Noted*
- Any discharges of groundwater will need to be sampled during construction and afterward. *Response*: *Noted*

AFPD-PREAPP-Scott Plumer- scott.plumer@arvadafire.com

- This application will be reviewed for compliance with the 2018 International Fire Code (IFC) as adopted by the City
 of Arvada under Article II of Chapter 42 in the Arvada City Code. The comments provided in this review are
 preliminary in nature and do not consist of an all-inclusive list of needs or requirements for this proposal. Building
 construction plans will be reviewed for compliance with the adopted IFC at the time of submission. Many times,
 sufficient drawings or information are not provided, therefore the comments below are general in nature. *Response: Noted*
- These comments pertain to the subdivision/rezoning/annexation only. Should any buildings or structures be built on any of the lots in the future, additional fire code requirements may apply. These may include, but are not limited to, fire apparatus access roads, fire hydrants, and/or fire sprinkler systems. AFPD shall receive a site plan to review for code compliance with the adopted fire code at the time of future submittals. *Response: Noted*
- Fire Lane and Fire Apparatus Access roads shall be provided with an approved all-weather surface (paved) that can support an imposed load of 85,000 pounds. And provide access to within 150 feet of all portions of the exterior of the structure(s).
 Response: Noted
- Due to building size and access distances, fire sprinklers will be required for all buildings on the site, except the northwest corner and the storage office.
 Response: All buildings except storage office have been removed from the site plan.
- The Fire Lane and Fire Apparatus Access roads shall provide a minimum inside turning radius and an outside turning radius sufficient to allow navigation of AFPD apparatus and allow effective emergency operations. A turning analysis of the site shall be provided and indicate that access throughout the site will accommodate AFPD Tower 56. The developer or representative shall reference the AFPD website for specifications.

Response: Noted

Dead-end fire apparatus access roads exceeding 150 feet shall be provided with an approved fire apparatus turnaround.

Response: Noted – No fire apparatus roads are proposed at this time.

The minimum width of the fire apparatus access roads shall be a clear and unobstructed 24 feet for building heights less than 30 feet. For building heights that exceed 30 feet in height, a 26-foot fire apparatus access road will be required.

Response: Noted – No fire apparatus roads are proposed at this time.

For buildings that exceed 30 feet in height, the fire apparatus access roads shall be positioned a minimum distance of 15 feet from the building and a maximum distance of 30 feet from the building. The road shall be positioned parallel to one entire side of the building.

Response: Noted – No buildings exceeding 30' in height are proposed at this time.

The approved Fire Lane and Fire Apparatus Access road(s) shall be provided during construction unless otherwise approved by the AFPD. The fire apparatus access roads shall consist of the first lift of asphalt or concrete and shall be provided prior to combustible materials being brought to the site and commencing vertical construction. Alternative temporary fire apparatus access road materials and/or designs shall be approved and permitted by the AFPD.

Response: Noted – No fire apparatus roads are proposed at this time.

- Fire lane signage plan shall be provided. Response: Noted – No fire apparatus roads are proposed at this time.
- A 3-foot clear space shall be maintained around all fire hydrants. The space shall be measured from the top center of the hydrant and there shall be no obstruction directly in front of a hydrant. All the trees within this development shall provide an unobstructed vertical clearance of 13 feet 6 inches for the fire apparatus access road. Response: Noted – No fire hydrants are proposed at this time.
- Fire hydrants shall be provided so that all portions of buildings are within 400-feet of a fire hydrant. The proximity shall be measured along the Fire Lane and Emergency Access road(s) to the building and via an approved route around the exterior of the building(s) at grade level. The proximity may be increased to 600- feet with installation of an approved fire sprinkler system.

Response: Noted – No fire hydrants are proposed at this time.

- A fire hydrant shall be provided within 150 feet of the fire department connection for buildings equipped with an automatic fire sprinkler system. Response: Noted – An existing fire hydrant is located at the intersection of 68th and Joyce, but no sprinkler system is proposed for the office building.
- The minimum fire-flow as determined by Arvada Fire shall be provided by the fixed-water distribution system. Fireflow is calculated using the total floor area of all floors within the exterior walls of the largest building and the construction type. Reduction in required fire-flow is allowed with installation of an approved fire sprinkler system and as approved by Arvada Fire. Response: Noted

PLN LANDSCAPE-PREAPP-Shane Greenburg-- sgreenburg@arvada.org

- Final plans must be stamped by a Colorado registered landscape architect. *Response*: Noted, final plans will be stamped.
- Along the northern, western, and southern property lines, use Type C bufferyard found in LDC 4-6-5-3 Bufferyard Options. To make up for the lack of trees within the parking area, add one extra tree and 5 extra shrubs per linear feet in addition to the bufferyard requirements. Along the northern and western boundaries, the fence or wall should be as close to the parking area as possible with the vegetation on the outside facing the trail to help maintain a more natural trail experience. No fences or walls within floodplain. See attached plan for examples.
 Response: Fencing and Type-C bufferyard added to plan, including additional shrubs and trees per requirement. Please note that along the southerly property line, the Bufferyard exceeds 20-feet due to the water line easement.
- 15% Minimum landscape area area includes all vegetated areas (including parking lot islands/bufferyards/detention basins) plus non-vehicular hardscaped areas intended for pedestrian or recreational uses.

Response: 28% landscape minimum area has been provided.

- If any trees are to be removed, follow requirements in 4-6-2 Tree Preservation and Replacement, including providing a tree survey by a licensed arborist or landscape architect. Trees that are saved offset trees that are removed. Tree caliper inches that cannot be mitigated on the site or the neighboring properties require a fee- in-lieu of \$300 per caliper inch. To find a certified arborist, visit https://isarmc.org/
 - *Response*: Tree survey included. Trees to be saved and trees to be removed noted on landscape plans.
- Follow requirements in LDC 4-3-2-2 Common Open Spaces. Provide an outdoor amenity for employees such as a picnic/seating area.
 Response: Outdoor seating area has been incorporated into site
 - Response: Outdoor seating area has been incorporated into site.
- All remaining landscape areas to follow requirements in LDC 4-6-6-5 General Landscape Areas. Follow requirements in LDC 4-6-4-3 Size and Quality of Landscape Plants.
 Response: Remaining landscape areas meet requirements.
- Follow requirements in LDC 4-6-7-1 Water-Wise Requirements. Pay special attention to D.Soil Amendments and F.Irrigation as landscape notes are required on the plans.
 Response: Landscape notes included on plans.
- All buildings must be ADA accessible from public rights-of-way and parking areas. *Response*: Noted, refer to civil plans for accessible route.
- On all vehicular entrances, follow requirements found in 4-4-3-3 Intersection Visibility. No plants over 2 feet tall at
 maturity should be within the site triangle. Trees may be allowed if trimmed up nine feet and the city staff believe
 the placement will not impede visibility. *Response*: There are no site triangles within the limits of this site.
- Please reference the City recommended/prohibited plant list https://arvada.org/source/LDC/Arvada%20Plant%20List%20-%209.1.2020.pdf
 Response: No plants on the prohibited plant list are included.
- No trees to be planted within utility easements or within 10 feet of a public utility line. *Response*: All trees have been placed more than 10 feet away from public utility lines.

LEGAL DESCRIPTION

AN IRREGULAR TRACT OF LAND LOCATED IN THE NORTHWEST 1/4 OF THE SOUTHEAST 1/4 AND THE SOUTHWEST 1/4 OF THE NORTHEAST 1/4 OF SECTION 1, TOWNSHIP 3 SOUTH, RANGE 70 WEST OF THE SIXTH PRINCIPAL MERIDIAN, LYING NORTH AND EAST OF THE CROKE CANAL AND SOUTH OF COTTONWOOD WEST INDUSTRIAL PARK FILING NO. 1. SITUATED IN THE CITY OF ARVADA, JEFFERSON COUNTY, COLORADO MORE PARTICULARLY DESCRIBED AS FOLLOWS:

BEGINNING AT THE NORTHEAST CORNER OF SAID NORTHWEST 1/4 OF THE SOUTHEAST 1/4; THENCE S0014'49"E ALONG THE EAST LINE OF SAID NORTHWEST 1/4 OF THE SOUTHEAST 1/4 A DISTANCE OF 463.73 FEET TO A POINT ON THE NORTHERLY RIGHT-OF-WAY LINE OF THE CROKE CANAL: THENCE ALONG THE NORTHERLY AND EASTERLY RIGHT-OF-WAY LINE OF THE CROKE CANAL THE FOLLOWING SIX (6)COURSES:

N8302'55"W A DISTANCE OF 150.11 FEET

ALONG A CURVE TO THE RIGHT HAVING A CENTRAL ANGLE OF 1123'39*. A RADIUS OF 963.78 FEET AND A CHORD WHICH BEARS N7721'05 W, AN ARC DISTANCE OF 191.66 FEET.

N71-39'16"W A DISTANCE OF 276.15 FEET;

ALONG A CURVE TO THE RIGHT, HAVING A CENTRAL ANGLE OF 373118*. A RADIUS OF 208.06 FEET AND A CHORD WHICH BEARS N52'53'37"W. AN ARC DISTANCE OF 136.25 FEET; N3407'58"W A DISTANCE OF 557.70 FEET:

ALONG A CURVE TO THE RIGHT. HAVING A CENTRAL ANGLE OF 11:3335, A RADIUS OF 388.56 FEET AND A CHORD WHICH BEARS N28'20'45 W. AN ARC DISTANCE OF 78.40 FEET TO THE SOUTHWEST CORNER OF SAID COTTONWOOD WEST INDUSTRIAL PARK FILING NO. 1:

THENCE ALONG THE SOUTHERLY BOUNDARY LINE OF SAID COTTONWOOD WEST INDUSTRIAL PARK FILING NO. 1 THE FOLLOWING THREE (3) COURSES:

N8404'28*E A DISTANCE OF 154.44 FEET; S80'49 37"E A DISTANCE OF 464.19 FEET:

N5357'00*E A DISTANCE OF 542.86 FEET TO A POINT ON THE EAST LINE OF SAID SOUTHWEST 1/4 OF THE NORTHEAST 1/4;

THENCE S0011'39"E ALONG THE EAST LINE OF THE SOUTHWEST 1/4 OF THE NORTHEAST 1/4 A DISTANCE OF 55.92 FEET TO THE POINT OF BEGINNING, COUNTY OF JEFFERSON, STATE OF COLORADO

PROJECT SUMMARY:

THIS PROJECT INCLUDES RV STORAGE AND A SMALL OFFICE BUILDING ON VACANT LAND.


GENERAL NOTES:

- 1. ANY PROPOSED FENCES, WALLS, SIGNS, AND ACCESSORY STRUCTURES SHOWN ON THIS PLAN AREA ILLUSTRATIVE ONLY AND SUBJECT TO SEPARATE REVIEWS AND PERMITS.
- 2. FIRE APPARATUS ROADS SHALL BE PROVIDED WITH AN APPROVED ALL-WEATHER SURFACE (CONCRETE OR ASPHALT) AND SHALL BE CAPABLE OF SUPPORTING AN IMPOSED LOAD OF 85,000 POUNDS.
- 3. THE APPROVED FIRE APPARATUS ROADS SHALL BE PROVIDED DURING CONSTRUCTION UNLESS OTHERWISE APPROVED BY THE AFPD. THE FIRE APPARATUS ACCESS ROADS SHALL CONSIST OF THE FIRST LIFT OF ASPHALT OR CONCRETE AND SHALL BE PROVIDED PRIOR TO COMMENCING VERTICAL CONSTRUCTION. ALTERNATIVE TEMPORARY FIRE APPARATUS ACCESS ROAD MATERIALS AND / OR DESIGNS SHALL BE APPROVED AND PERMITTED BY THE AFPD. THE PRIVATE ROADS THROUGH THE SITE SHALL BE DEDICATED ON THE FINAL PLAT AS "FIRE APPARATUS ACCESS ROADS" OR OTHER SIMILAR LANGUAGE AS REQUIRED BY THE CITY OF ARVADA.
- 4. A 3'-0" CLEAR SPACE SHALL BE MAINTAINED AROUND ALL FIRE HYDRANTS AND NOT OBSTRUCTED.
- 5. FIRE HYDRANTS SHALL BE INSTALLED AND OPERATIONAL TO PROVIDE THE MINIMUM REQUIRED FIRE FLOW PRIOR TO COMMENCING VERTICAL CONSTRUCTION.
- 6. DURING CONSTRUCTION AND UPON COMPLETION, THERE SHALL BE BUILDING SIGNAGE PROVIDED, A MINIMUM OF 0'-4" HIGH WITH A 0.5' STROKE AND VISIBLE FROM THE STREET OR ROAD FRONTING SUCH BUILDING.

GOLDEN RV STORAGE

SITUATED IN THE NORTHEAST 1/4 AND THE SOUTHEAST 1/4 OF SECTION 1, TOWNSHIP 3 SOUTH, RANGE 70 WEST OF THE 6TH P.M., COUNTY OF JEFFERSON, STATE OF COLORADO

VICINITY MAP

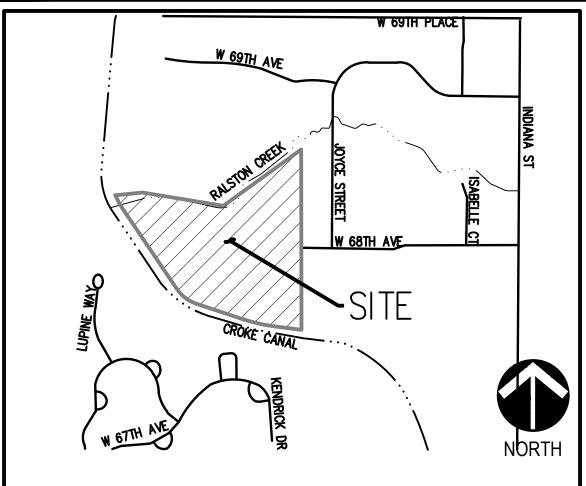

SHEET INDEX

r	1
1	COVER SHEET
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15	PHOTOMETRIC SHEET
16	PHOTOMETRIC SHEET

CITY REVIEW TEAM

PLANNING:

DEVELOPMENT ENGINEERING/ TRAFFIC:

ARVADA FDP:

LANDSCAPE REVIEW:

LAND DIVISION:

STORM WATER:

SITE DATA

LOT	STANDARDS
NUM	BER OF RV STORAG
MIN.	LOT AREA
MIN.	LOT WIDTH
MIN.	LOT COVERAGE
MAX.	OUTDOOR STORAG
SETE	BACK STANDARDS
MIN.	FRONT
MIN.	STREET SIDE
MIN.	INTERIOR SIDE
MIN.	FRONT PARKING
MIN.	REAR SETBACK
BUIL	DING STANDARDS
MAX.	HEIGHT, BUILDING
MIN.	LANDSCAPE SURFA

PROJECT CONTACTS

OWNER: CHELTON LLC PO BOX 460010 FORT LAUDERDALE, FLORIDA 33346

DEVELOPER/APPLICANT: SPIRIT LAKE 5 LLC 12460 1ST STREET, EASTLAKE, COLORADO 80614 PHONE: 303-457-5717 CONTACT: BRADLEY PENWELL

PLANNER: NORRIS DESIGN 1101 BANNOCK STREET DENVER, COLORADO 80204 PHONE: 303-892-1166 CONTACT: BONNIE NIZIOLEK

ARCHITECT:

HAUSER 3780 EAST 15TH STREET, SUITE 201 LOVELAND, COLORADO 80202 PHONE: 970-669-8220 CONTACT: CURTIS KOLDEWAY

CIVIL ENGINEER:

HKS 1120 LINCOLN ST, SUITE 1000 DENVER, COLORADO 80203 PHONE: 303623-6300 CONTACT: KEVIN KENNEDY

SURVEYOR:

HKS 1120 LINCOLN ST, SUITE 1000 DENVER, COLORADO 80203 PHONE: 303-623-6300 CONTACT: KEVIN KENNEDY



1101 Bannock Street Denver, Colorado 80204 P 303.892.1166 www.norris-design.com

	REQUIRED	PROPOSED	
E SPACES	N/A	556 SPACES	
	N/A	14 AC/ 609,840 SF	
	N/A	N/A	
	50%, 304,920 SF	0.32%, 1,890 SF	
E OF LOT AREA	35%, 213,444 SF	32%, 192,097.25 SF	
	20 FT.	20 FT.	
	20 FT.	20 FT.	
	5 FT.	20 FT.	
	20 FT.	20 FT.	
	5 FT.	772 FT.	
	40 FT.	17'-1" FT.	
CE AREA	15%	28%	

LANDSCAPE ARCHITECT: NORRIS DESIGN 1101 BANNOCK STREET DENVER, COLORADO 80204 PHONE: 303-892-1166 CONTACT: BRAD HAIGH

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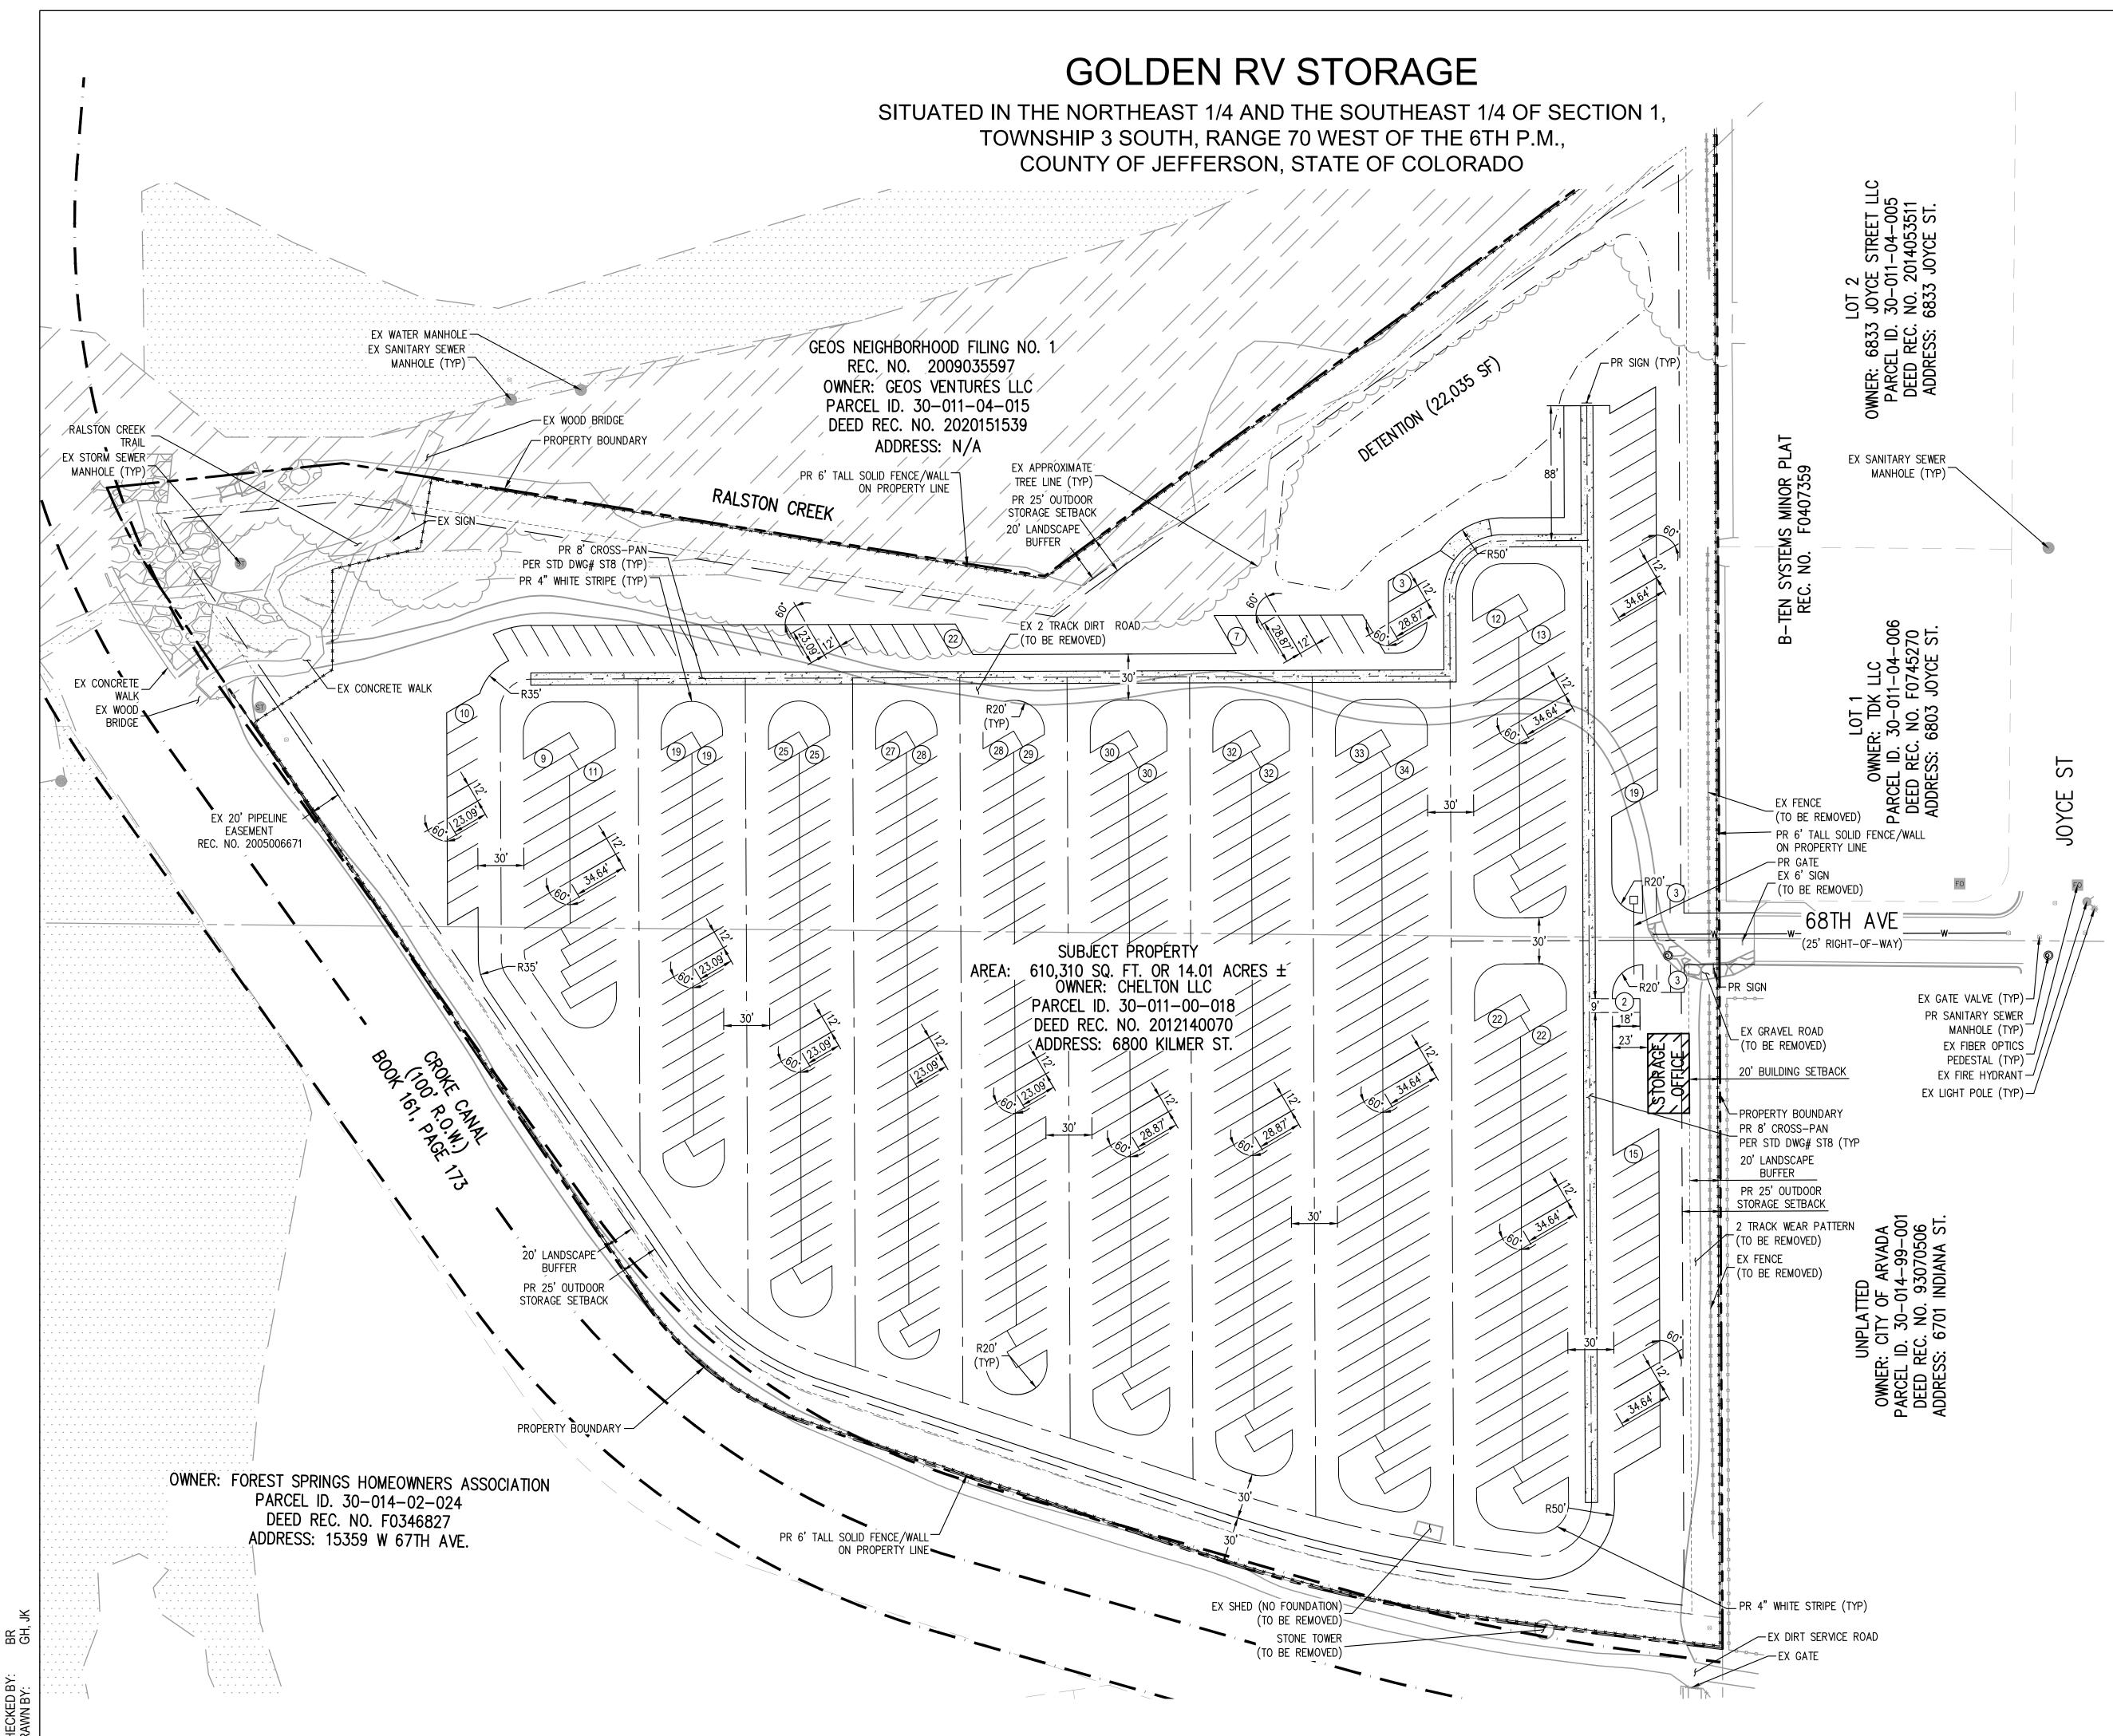
OWNER: CHELTON LLC PO BOX 460010 FORT LAUDERDALE, FL 33346

NOT FOR CONSTRUCTION

DATE: <u>12/03/21 - 1ST SUB</u>

> SHEET TITLE: COVER SHEET

SHEET 1 OF 16





1101 Bannock Street Denver, Colorado 80204 P 303.892.1166 www.norris-design.com

	PROPERTY BOUNDARY
Py -	EX LOT LINE
	EX EDGE OF ROAD
	EX FENCE

LEGEND:

X FENCE	
X WOOD FENCE	0000000000000
X STORM SEWER MANHOLE	ST
X SANITARY SEWER MANHOLE	69
X WATER MANHOLE	•
X GATE VALVE	181
X FIRE HYDRANT	
X FIBER OPTICS PEDESTAL	FO
X LIGHT POLE	*
X SIGN	
LOOD ZONE AE - 0.2% ANNUAL CHANCE	· · · · · · · · · · · · · · · · · · ·
LOOD ZONE AE - SPECIAL FLOOD HAZARD AREA	
R EDGE OF ROAD	
R 8' CONCRETE PAN	
R SANITARY SEWER MANHOLE	O
R LANDSCAPE BUFFER	
R SETBACK	
R FENCE	
R GATE	D
R SIGN	- *-
R BUILDING	
R PARKING STRIPE	
R PARKING COUNT	(XX)
R 4" WHITE STRIPE	
R ROAD CENTERLINE	
R DETENTION POND	
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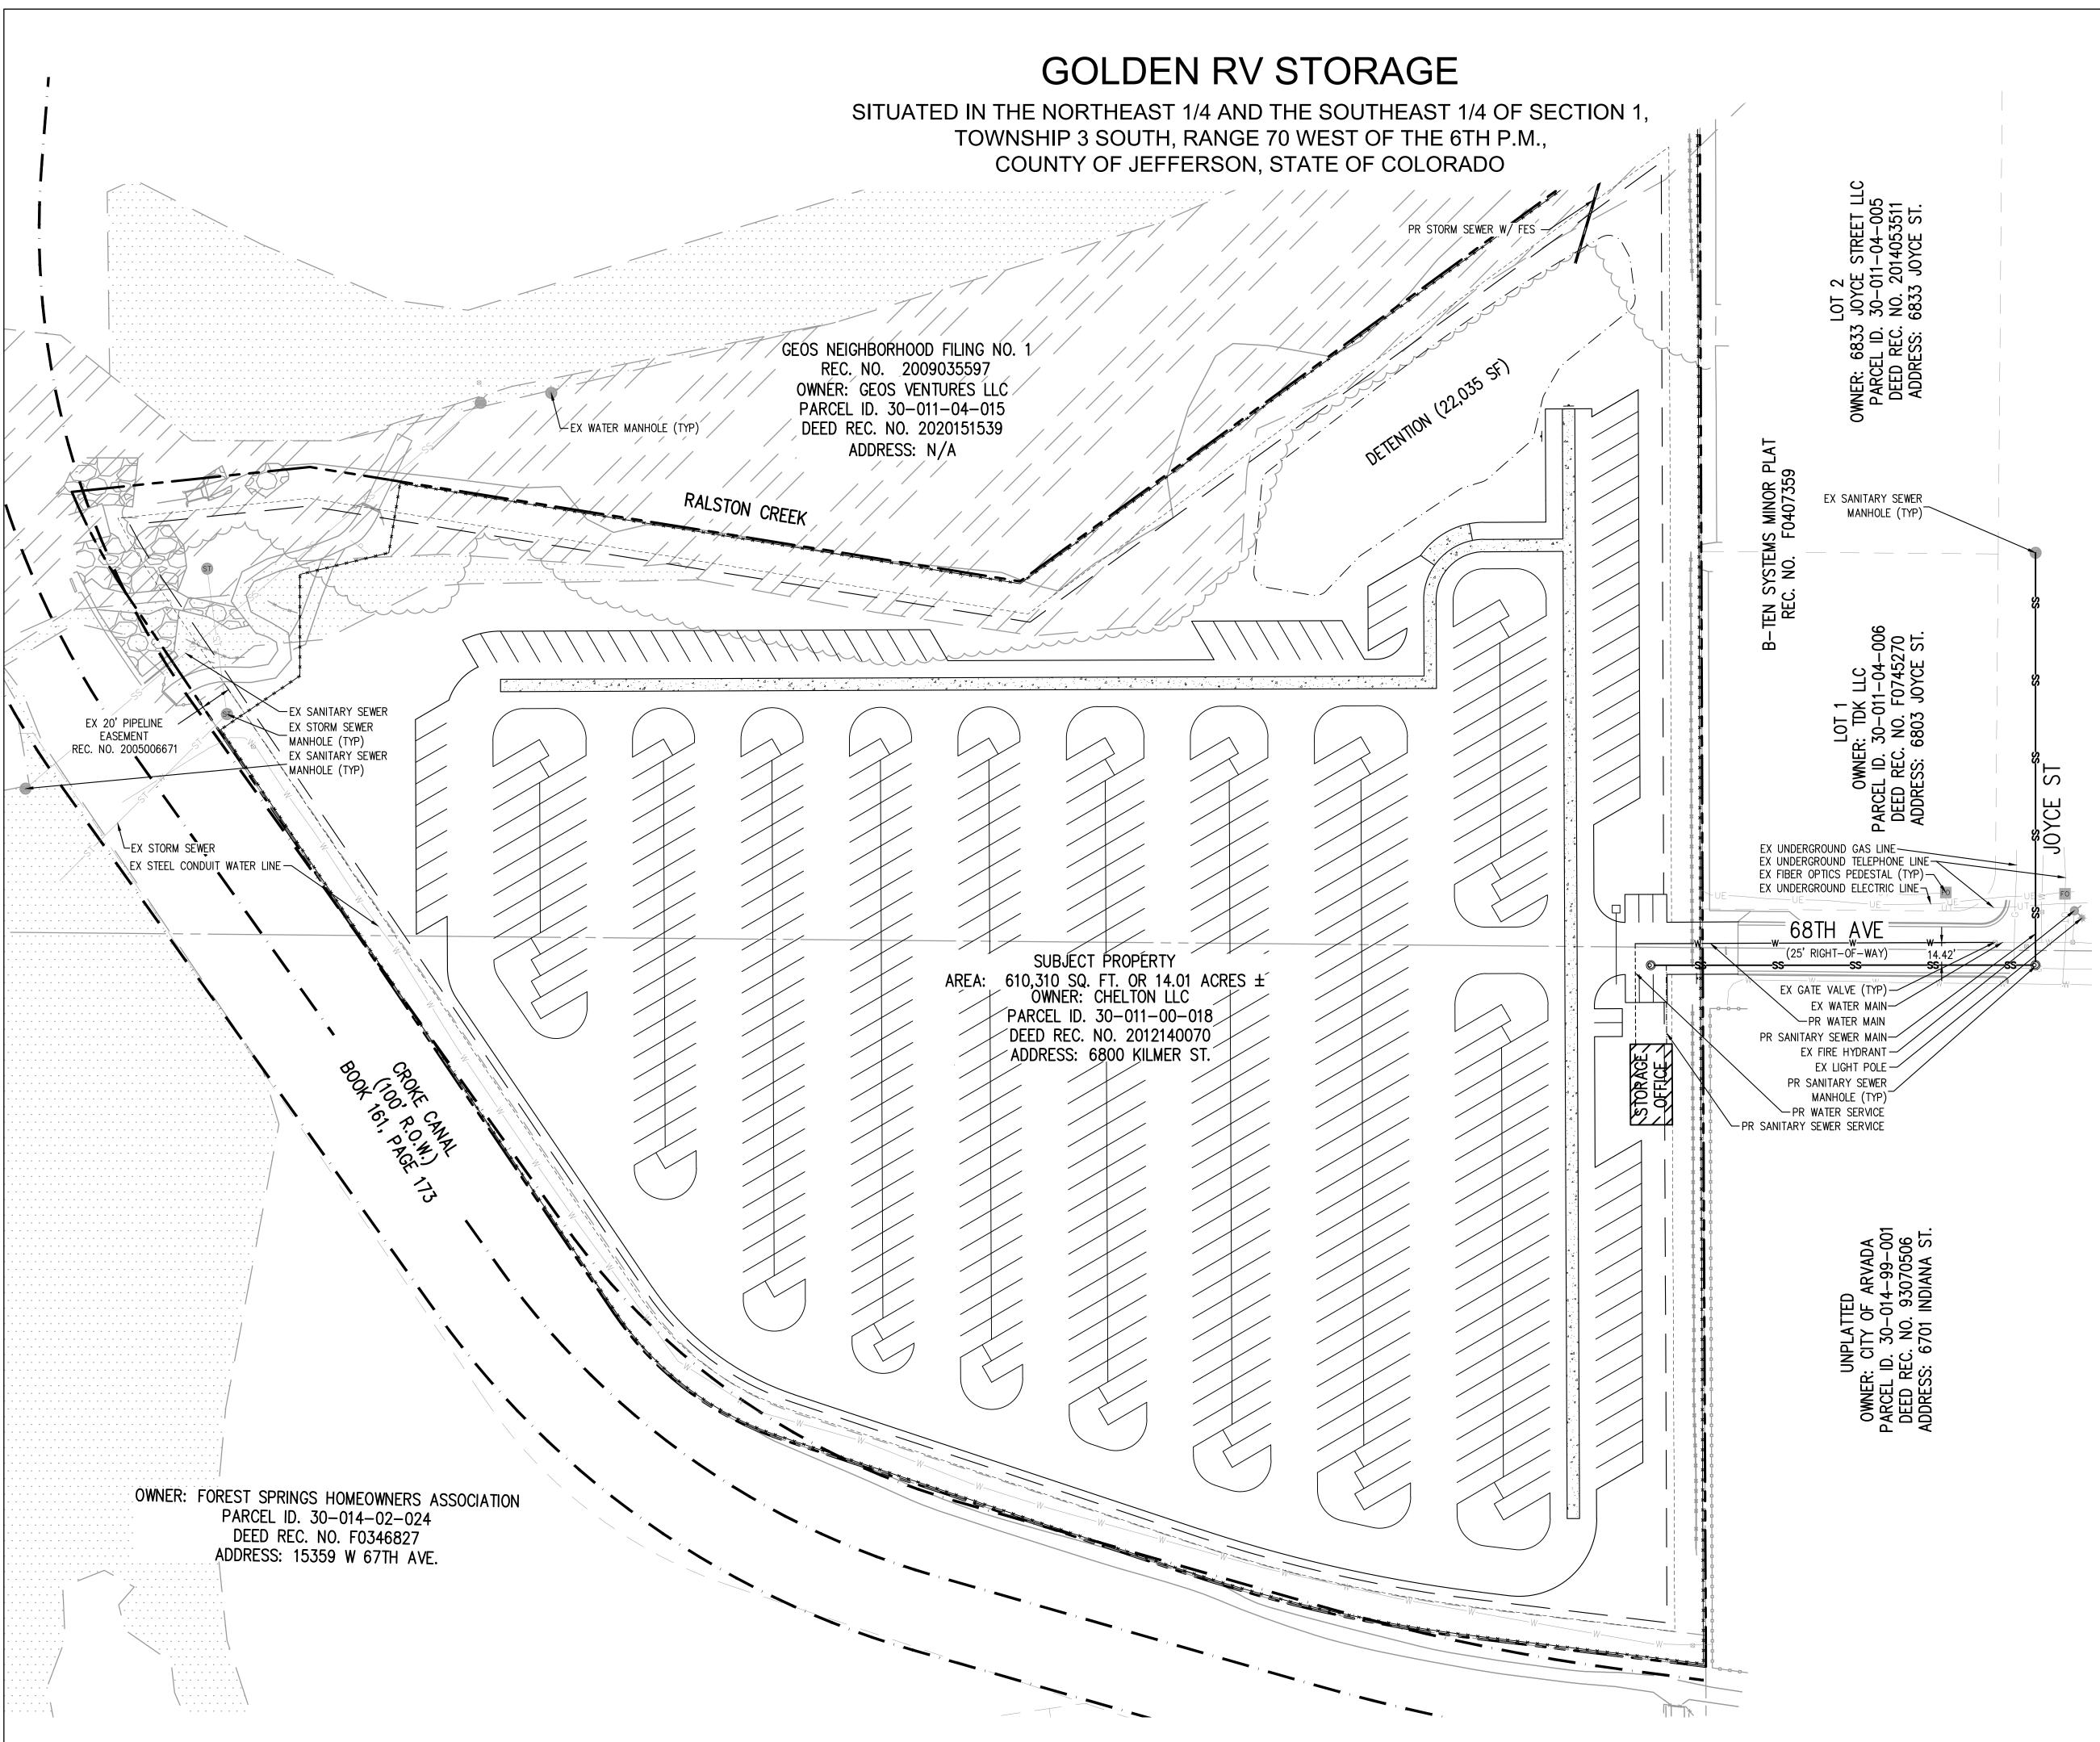
NOT FOR CONSTRUCTION

DATE: <u> 12/03/21 - 1ST SUB</u>

SHEET TITLE:

SITE PLAN

SCALE: 1" = 50'



CHECKED BY DRAWN BY:

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1101 Bannock Street Denver, Colorado 80204 P 303.892.1166 www.norris-design.com

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PROPERTY BOUNDARY	
EX LOT LINE	
EX EDGE OF ROAD	
EX FENCE	* * * * * * * * * * * * * *
EX WOOD FENCE	
EX UNDERGROUND GAS LINE	G
EX UNDERGROUND TELEPHONE LINE	UT
EX UNDERGROUND ELECTRIC LINE	UE
EX SANITARY SEWER MAIN	SS
EX WATER MAIN	WW
EX STORM SEWER	ST
EX STORM SEWER MANHOLE	ST
EX SANITARY SEWER MANHOLE	69
EX WATER MANHOLE	•
EX GATE VALVE	101
EX FIRE HYDRANT	€(
EX FIBER OPTICS PEDESTAL	FO
EX LIGHT POLE	*
EX SIGN	
FLOOD ZONE AE - 0.2% ANNUAL CHANCE	· · · · · · · · · · · · · · · · · · ·
FLOOD ZONE AE - SPECIAL FLOOD HAZARD AREA	
PR EDGE OF ROAD	
PR 6' CONCRETE PAN	
PR STORM W/ FES	
PR WATER MAIN	WW
PR WATER SERVICE LINE	
PR SANITARY SEWER MAIN	SS
PR SANITARY SEWER SERVICE LINE	
PR SANITARY SEWER MANHOLE	Ø
PR LANDSCAPE BUFFER	
PR SETBACK	
PR FENCE	_ _
PR GATE	D
PR SIGN	-
PR BUILDING	
PR PARKING STRIPE	
PR 4" WHITE STRIPE	
PR DETENTION POND	
	100

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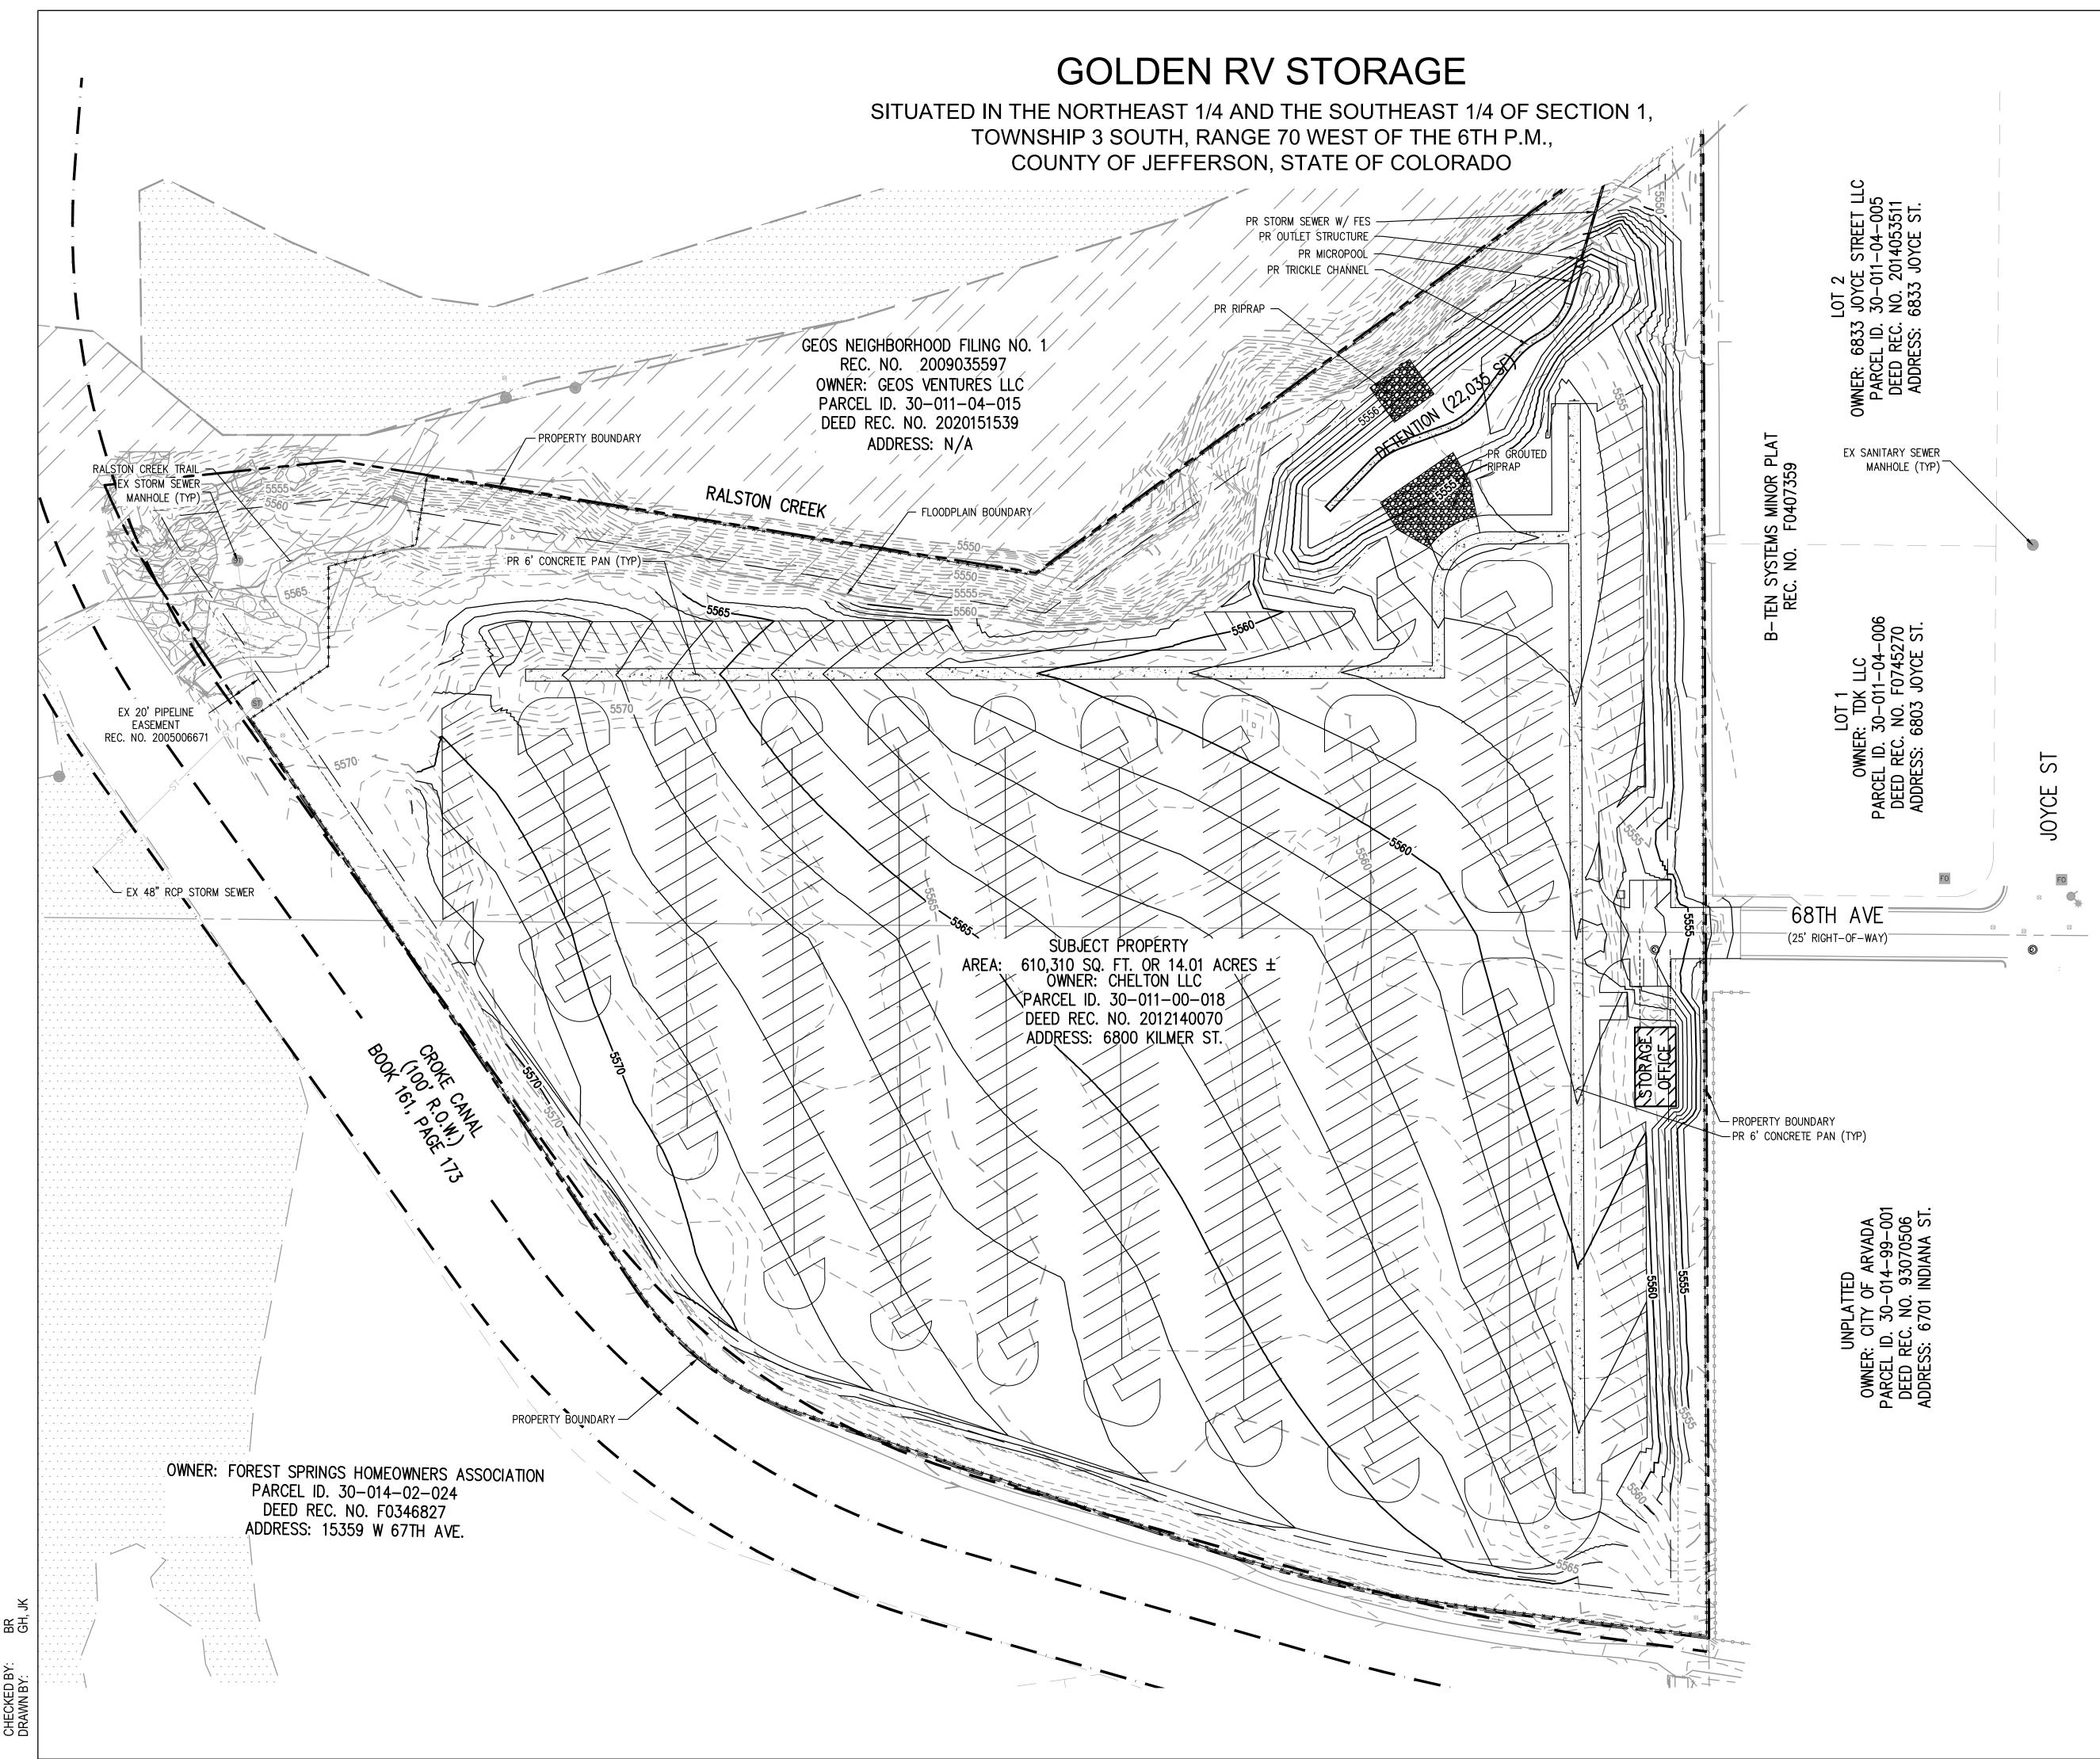
NOT FOR CONSTRUCTION

DATE: <u> 12/03/21 - 1ST SUB</u>

> SHEET TITLE: OVERALL UTILITY PLAN

3 SISEEET 3007F186

SCALE: 1" = 50'




GENERAL GRADING NOTES: 1. THE CONTRACTOR IS RESPONSIBLE FOR ENSURING THAT HANDRAILS, STAIRS, CURB RAMPS, AND RAMPS ARE INSTALLED IN CONFORMANCE WITH ALL APPLICABLE LOCAL STATE AND/OR FEDERAL REGULATIONS AND STANDARDS, INCLUDING BUT NOT LIMITED TO, THE AMERICANS WITH DISABILITIES ACT (ADA), THE FAIR HOUSING ACT (FHA) AND THE AMERICAN NATIONAL STANDARDS INSTITUTE (ANSI).

- 2. CROSS SLOPES ALONG THE ACCESSIBLE ROUTE OR AT LANDINGS SHALL NOT EXCEED 2% IN ANY DIRECTION.
 3. LONGITUDINAL SLOPES ALONG THE ACCESSIBLE ROUTE SHALL NOT EXCEED
- LONGITUDINAL SLOTES ALONG THE ACCESSIBLE ROOTE STALE NOT EXCEED 5%. LONGITUDINAL SLOPES ON RAMPS SHALL NOT EXCEED 8.33%. RAMPS, EXCEPT CURB RAMPS, SHALL HAVE HANDRAILS ON BOTH SIDES.
 GUTTER SLOPES AT THE CURB RAMPS SHALL NOT EXCEED 5%.
- GUTTER PANS SURROUNDING HANDICAP SPACES SHALL MATCH THE SLOPE OF THE ADJACENT PAVEMENT WITH A MAXIMUM 2% SLOPE IN ALL DIRECTIONS.
 ALL GRADES ARE FINISHED GRADE, UNLESS OTHERWISE NOTED.
- ALL GRADES ARE FINISHED GRADE, UNLESS OTHERWISE NOTED.
 ROCK MULCH, IF PLACED UPSTREAM OF CONCRETE FLATWORK OR GRASSED AREA, SHALL BE PLACED ON TOP OF FINISHED GRADE SHOWN ON THESE PLANS. ROCK MULCH AREAS SHALL BE DESIGNED AND CONSTRUCTED TO ADEQUATELY DRAIN AND NOT RETAIN WATER. ALL LANDSCAPE EDGE MATERIALS SHALL NOT PREVENT DRAINAGE TO PASS THROUGH.
- ALL GRADES ADJACENT TO THE BUILDINGS SHALL BE AT MINIMUM 8-INCHES BELOW FINISHED FLOOR ELEVATION, UNLESS OTHERWISE NOTED.
 NON-PAVED GRADES ADJACENT TO BUILDINGS SHALL SLOPE AWAY FROM ALL BUILDINGS AT A MINIMUM OF ??% FOR ??-FT. ALL PAVED GRADES ATTACHED TO BUILDINGS SHALL SLOPE AWAY FROM ALL BUILDINGS AT A
- MINIMUM OF 1%, UNLESS OTHERWISE NOTED.
 10. ALL GRADES FOR WALLS ARE FINISHED GRADE ELEVATIONS AT BOTTOM OF FRONT FACE (BW) AND TOP-BACK OF WALL (TW). THE WALL ELEVATIONS DO NOT INDICATE FOUNDATION DEPTHS OR ELEVATIONS. RETAINING WALL DETAILS SHALL BE PROVIDED BY OTHERS.
- 11. REFER TO STRUCTURAL PLANS FOR BUILDING FOUNDATION STEP LOCATIONS WHEN APPLICABLE.
- PORTIONS OF STAIRS THAT DO NOT MEET THE MINIMUM 4-INCH RISER HEIGHT (DUE TO AN ADJACENT SLOPING PUBLIC WAY) SHALL HAVE A DISTINCTIVE MARKING STRIPE, 1-INCH TO 2-INCHES IN WIDTH, WITH A SLIP-RESISTANT SURFACE, IN ACCORDANCE WITH CURRENT INTERNATIONAL BUILDING CODE REGULATIONS.
- SEE LANDSCAPE ARCHITECT PLANS FOR HEIGHT AND TOP OF COURTYARD AMENITIES (PLANTER CURBS, SEAT WALLS, BENCHES, FIRE WALL, MEDIA WALL, BARS, AND GRILLS).
 TOP STEP ELEVATIONS FOR STOOPS AND PATIOS ARE SHOWN FOR
- 14. TOP STEP ELEVATIONS FOR STOOPS AND PATIOS ARE SHOWN FOR REFERENCE ONLY. TOP OF STEPS AND PATIO ELEVATIONS SHALL BE COORDINATED WITH ARCHITECTURAL PLANS/DETAILS AND AS-BUILT STOOP/PATIO ELEVATIONS.
- 15. ELECTRICAL TRANSFORMER PADS AND AC-UNIT PADS ARE TO BE SET A MINIMUM OF 2-INCHES ABOVE THE ADJACENT FINISHED GRADE AROUND THE PERIMETER OF THE PAD. CONTRACTOR SHALL PROVIDE A CONCRETE TURNDOWN AS NECESSARY. CONTRACTOR IS TO VERIFY POSITIVE DRAINAGE AWAY FROM, AND AROUND, ALL ELECTRICAL PADS AND AC-UNIT PADS.
- 16. SITE GRADING SHALL BE PERFORMED IN ACCORDANCE WITH THESE PLANS AND SPECIFICATIONS, AND THE RECOMMENDATIONS SET FORTH IN THE GEOTECHNICAL ENGINEERING REPORT.
- 17. CONTRACTOR SHALL ENSURE ACCESSIBLE EXTERIOR DOORS AND GATES ARE CONSTRUCTED WITH ADEQUATE LANDING WIDTH AND DEPTH TO COMPLY WITH APPLICABLE AMERICANS WITH DISABILITIES ACT (ADA) AND AMERICAN NATIONAL STANDARDS INSTITUTE (ANSI) MANEUVERING CLEARANCES AT DOOR REQUIREMENTS (BASED ON THE DIRECTION OF APPROACH OF THE SIDEWALK).

APPROACH OF THE SIDEWALK).	
LEGEND:	
PROPERTY BOUNDARY	
EX LOT LINE	
EX CONTOURS	5320
EX EDGE OF ROAD	
EX FENCE	*************************************
EX WOOD FENCE	
EX STORM SEWER	ST
EX STORM SEWER MANHOLE	ST
EX SANITARY SEWER MANHOLE	65
EX WATER MANHOLE	
EX GATE VALVE	181
EX FIRE HYDRANT	€(
EX FIBER OPTICS PEDESTAL	FO
EX LIGHT POLE	*
EX SIGN	
FLOOD ZONE AE - 0.2% ANNUAL CHANCE	
FLOOD ZONE ZE - SPECIAL FLOOD HAZARD AREA	
PR CONTOURS	5320
PR EDGE OF ROAD	
PR 6' CONCRETE PAN	Δ
PR STORM SEWER W/ FES	
PR SANITARY SEWER MANHOLE	Ø
PR LANDSCAPE BUFFER	
PR SETBACK	
PR FENCE	
PR GATE	
PR SIGN	
PR BUILDING	
PR PARKING STRIPE	
PR 4" WHITE STRIPE	
PR DETENTION POND	
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NOT FOR CONSTRUCTION

DATE: <u>12/03/21 - 1ST SUB</u>

SHEET TITLE: OVERALL GRADING PLAN

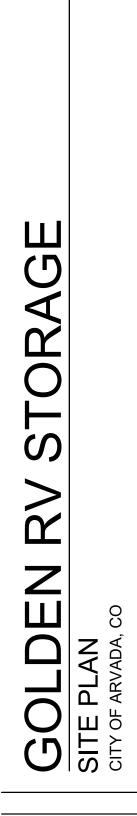4 SISENEET 4007F186

SCALE: 1" = 50'

GENERAL NOTES

- ANY PROPOSED FENCES, WALLS, SIGNS AND ACCESSORY STRUCTURES SHOWN ON THIS PLAN ARE ILLUSTRATIVE ONLY AND SUBJECT TO SEPARATE REVIEWS AND PERMITS.
- 2. FIRE APPARATUS ACCESS ROADS SHALL BE PROVIDED WITH AN APPROVED ALL-WEATHER SURFACE (CONCRETE OR ASPHALT) AND SHALL BE CAPABLE OF SUPPORTING AN IMPOSED LOAD OF 85,000 POUNDS.
- 3. THE APPROVED FIRE APPARATUS ACCESS ROADS SHALL BE PROVIDED DURING CONSTRUCTION UNLESS OTHERWISE APPROVED BY THE AFPD. THE FIRE APPARATUS ACCESS ROADS SHALL CONSIST OF THE FIRST LIFT OF ASPHALT OR CONCRETE AND SHALL BE PROVIDED PRIOR TO COMMENCING VERTICAL CONSTRUCTION. ALTERNATIVE TEMPORARY FIRE APPARATUS ACCESS ROAD MATERIALS AND/OR DESIGNS SHALL BE APPROVED AND PERMITTED BY THE AFPD. THE PRIVATE ROADS THROUGH THE SITE SHALL BE DEDICATED ON THE FINAL PLAT AS "FIRE APPARATUS ACCESS ROADS" OR OTHER SIMILAR LANGUAGE AS REQUIRED BY THE CITY OF ARVADA
- 4. A 3'- 0" CLEAR SPACE SHALL BE MAINTAINED AROUND ALL FIRE HYDRANTS AND NOT OBSTRUCTED.
- 5. FIRE HYDRANTS SHALL BE INSTALLED AND OPERATIONAL TO PROVIDE THE MINIMUM REQUIRED FIRE FLOW PRIOR TO COMMENCING VERTICAL CONSTRUCTION.
- 6. DURING CONSTRUCTION AND UPON COMPLETION THERE SHALL BE BUILDING SIGNAGE PROVIDED, A MINIMUM OF 0'- 4" INCHES HIGH WITH A 0.5" STROKE AND VISIBLE FROM THE STREET OR ROAD FRONTING THAT BUILDING.

PLANTING NOTES

- ALL PLANT MATERIAL SHALL MEET SPECIFICATIONS OF THE AMERICAN ASSOCIATION OF NURSERYMEN (AAN) FOR SPECIMEN GRADE. ALL TREES SHALL BE BALLED AND BURLAPPED OR EQUIVALENT. ALL PLANT MATERIAL SHALL HAVE ALL NON-BIODEGRADABLE STRING AND WIRE REMOVED FROM TRUNK AND ROOT BALL PRIOR TO PLANTING.
- 2. ALL TREES AND SHRUBS SHALL BE INSTALLED USING ONLY THE BEST INSTALLATION PRACTICES, EACH HOLE SHALL BE DUG TO A MINIMUM OF 2 TIMES LARGER THAN THE ROOTBALL, ALL 2" CAL, AND UP DECIDUOUS TREES AND 6' HT, AND UP EVERGREENS SHALL BE PROPERLY STAKED FOR A PERIOD OF 1 YEAR. NO SHRUB SHOULD BE PLANTED WITHIN FIVE FEET (5') RADIUS OF TREE WITHIN TEN FEET (1 0? OF WATER METERS, FIRE DEPARTMENT CONNECTIONS, SANITARY SEWER MANHOLES, OR STORMWATER, WATER AND SANITARY SEWER LINES.
- 3. LOCATIONS OF ALL UTILITIES SHALL BE VERIFIED IN THE FIELD PRIOR TO PLANTING. TREE PLANTING SHALL BE COORDINATED WITH THE APPLICABLE SERVICE COMPANY.
- 4. GRADES SHALL BE SET TO ALLOW FOR PROPER DRAINAGE AWAY FROM STRUCTURES. GRADES SHALL MAINTAIN SMOOTH PROFILES AND BE FREE OF SURFACE DEBRIS. BUMPS AND DEPRESSIONS.
- 5. PRIOR TO INSTALLATION OF MATERIALS, AREAS THAT HAVE BEEN COMPACTED OR DISTURBED BY CONSTRUCTION ACTIVITY SHALL BE THOROUGHLY LOOSENED: ORGANIC SOIL AMENDMENTS SHALL BE INCORPORATED AT THE RATE OF AT LEAST FOUR (4) CUBIC YARDS PER 1000 SQUARE FEET OF LANDSCAPE AREA.
- 6. CONTRACTOR SHALL VERIFY ALL MATERIAL QUANTITIES PRIOR TO INSTALLATION. ACTUAL NUMBER OF PLANT SYMBOLS SHALL HAVE PRIORITY OVER THE QUANTITY DESIGNATED.
- 7. FIELD STAKE ALL TREE LOCATIONS BASED UPON TI-IE PLANS, OBTAIN APPROVAL OF OWNER'S REPRESENTATIVE FOR STAKED LOCATIONS PRIOR TO PLANTING.
- 8. CONTRACTOR SHALL BE RESPONSIBLE FOR MAINTAINING ALL PLANT MATERIAL INCLUDING SOD/SEED AREAS IN A HEALTHY STATE DURING CONSTRUCTION AND UNTIL FINAL ACCEPTANCE, ANY DAMAGE OR DEATH OF PLANT MATERIAL TO BE REPAIRED OR REPLACED AT THE CONTRACTOR'S EXPENSE.
- 9. CONTRACTOR SHALL INSURE THAT THE LANDSCAPE PLAN IS COORDINATED WITH PLANS PREPARED BY OTHERS SO THAT PROPOSED GRADING, STORM DRAINAGE, OR OTHER CONSTRUCTION DOES NOT CONFLICT WITH NOR PRECLUDE INSTALLATION AND MAINTENANCE OF LANDSCAPE ELEMENTS DESIGNATED ON THIS PLAN.

LANDSCAPE AREA	LINEAR FEET	TREES REQUIRED (3 TREES / 100 LF)	TREES PROVIDED	EXISTING TREES	SHRUBS REQUIRED (15 SHRUBS / 100 LF)	SHRUBS PROVIDED
SOUTH BUFFER	952 LF	29	27	4	143	148
WEST BUFFER	227 LF	7	3	4	35	38
NORTH BUFFER	840 LF	25	0	61	126	

LANDSCAPE AREAS REQUIREMENT TABLE

GOLDEN RV STORAGE

SITUATED IN THE NORTHEAST 1/4 AND THE SOUTHEAST 1/4 OF SECTION 1. TOWNSHIP 3 SOUTH, RANGE 70 WEST OF THE 6TH P.M., COUNTY OF JEFFERSON, STATE OF COLORADO

LANDSCAPE NOTES

- 1. SITE SHALL BE LANDSCAPED PRIOR TO ISSUANCE OF A FINAL CERTIFICATE OF OCCUPANCY (CO) DURING THE GROWING SEASON OF APRIL 1ST TO OCTOBER 1ST, AT ALL OTHER TIMES THE INDIVIDUAL SITES SHALL BE LANDSCAPED WITHIN 45 (FORTY-FIVE) DAYS OF THE START OF THE FOLLOWING GROWING SEASON. 2. LANDSCAPE MAINTENANCE
- 2.1. ALL PLANTS SHALL BE MAINTAINED CONTINUALLY IN A HEALTHY CONDITION IN ACCORDANCE WITH GENERALLY ACCEPTED PROFESSIONAL HORTICULTURAL STANDARDS AND
- PRACTICES. PLANTS THAT DIE OR ARE UNHEALTHY SHALL BE REPLACED ACCORDING TO THE APPROVED LANDSCAPE PLAN. REGULAR PRUNING AND TRIMMING SHALL BE PERFORMED TO MAINTAIN HEALTH AND AN ATTRACTIVE APPEARANCE AND TO PERMIT THE PLANTS TO ACHIEVE THEIR INTENDED 2.2. FORM AND HEIGHT.
- ALL LANDSCAPE AREAS SHALL BE KEPT FREE OF WEEDS. LITTER AND TRASH AND ALL IRRIGATION SYSTEMS SHALL BE PROPERLY MAINTAINED. 3. ALL LANDSCAPE AREAS SHALL BE IRRIGATED WITH UNDERGROUND AUTOMATIC IRRIGATION SYSTEM. TREES, SHRUBS, AND DECORATIVE GRASSES WILL BE IRRIGATED BY A SEPARATE
- ZONE FROM SOD/GRASS; THIS INCLUDES TREES PLANTED IN SOD/GRASS AREA. THE IRRIGATION SYSTEM IS TO HAVE A RAIN SENSOR SHUT-OFF INSTALLED. LANDSCAPING THAT LIES WITHIN SITE TRIANGLES SHALL NOT GROW TO BE OVER 2'-6" IN HEIGHT.
- TREES AND LANDSCAPING WITHIN DEVELOPMENTS, WHEN FULLY MATURE, SHALL PROVIDE AN UNOBSTRUCTED VERTICAL CLEARANCE OF 13'- 6" AND PROVIDE THE MINIMUM UNOBSTRUCTED FIRE APPARATUS ACCESS ROAD WIDTH AS REQUIRED BASED ON THE HEIGHT OF THE BUILDING.

PLANT SCHEDULE

						\frown	QTY SYM	COMMON NAME	BOTANICAL NAME	SIZE	WATER USE
DR	YLAND S	SEED MIX				()	DECIDUOUS	S TREES		1	
	•					(•)	CEL	WESTERN HACKBERRY	CELTIS OCCIDENTALIS	2" CAL. B&B	LOW
* * * * * * *	*	S MIXTURE" BY ARKANSAS V	ALLEY SEED CO, OR A	APPROVED EQUAL		\setminus /	IMP	IMPERIAL HONEYLOCUST	GLEDITSIA TRIACANTHOS INERMIS IMPERIAL	2" CAL. B&B	LOW
¥ ¥ * * *		NAME BOTAN	IICAL NAME	% OF TOTAL	PLS/ACRE		QUR	ENGLISH OAK	QUERCUS ROBUR	2" CAL. B&B	LOW
IRRIGA		WHEATGRASS AGROI	PYRON CRISTATUM	25%	6.25		SWO	SWAMP WHILE OAK	QUERCUS BICOLOR	2" CAL. B&B	LOW
	MOUNTAIN		JS MARGINATUS	20%	5.00	\bigcap					
			CA TRACHYPHYLLA/LO		3.75	(\cdot)	ORNAMENTA	AL TREES			
	ANNUAL R	YEGRASS LOLIUI	M PERENNE SSP. MUL	TIFLORUM 15%	3.75	\bigcirc	ССР	CHANTICLEER PEAR	PYRUS CALLERYANA 'CHANTICLEER'	2" CAL. B&B	MODERATE
	CANADA BI	LUEGRASS POA C	OMPRESSA	10%	2.50		DOW	WASHINGTON HAWTHORN	CRATAEGUS PHAENOPYRUM	2" CAL. B&B	LOW
	SIDEOATS	GRAMA BOUTE	LOUA CURTIPENDULA	A 5%	1.25		GMT	TATARIAN MAPLE	ACER TATARICUM	2" CAL. B&B	LOW
	LITTLE BLU	JESTEM SCHIZ	ACHYRIUM SCOPARIU	M 5%	1.25		ТСН	THORNLESS COCKSPUR HAWTHORN	CRATAEGUS CRUS-GALLI INERMIS	2" CAL. B&B	LOW
	BLUE GRAI SAND DRO		ELOUA GRACILIS DBOLUS CRYPTANDRU	4% JS 1%	1.00 .25	(+)	EVERGREEN	TREES/LARGE SHRUBS			
				TOTAL 100%	25 LBS.	(+)	AUS	AUSTRIAN PINE	PINUS NIGRA	6'-12' HT. B&B	LOW
				TOTAL 100%	20 LB3.	\smile	BOP	BOSNIAN PINE	PINUS HELDREICHII VAR. LEUCODERMIS	6'-12' HT. B&B	LOW
							PIN	PINON PINE	PINUS EDULIS	6'-12' HT. B&B	LOW
							PON	PONDEROSA PINE	PINUS PONDEROSA	6'-12' HT. B&B	LOW
						+ $+$	EVERGREEN	/BROADLEAF EVERGREEN SHRUBS			
						Ū.	ВСН	BLUE CHIP JUNIPER	JUNIPERUS HORIZONTALIS 'BLUE CHIP'	#5 CONT.	LOW
							BSG	SPANISH GOLD BROOM	CYTISUS PURGAN 'SPANSIH GOLD'	#5 CONT.	LOW
	NDSCAPE AI	REAS REQUIREMEN	IADLE				BUF	BUFFALO JUNIPER	JUNIPERUS SABINA 'BUFFALO'	#5 CONT.	LOW
						1	MPA	PANCHITO MANZANITA	ARCTOSTAPHYLOS 'PANCHITO'	#5 CONT.	LOW
ANDSCAPE	LINEAR FEET/SQUARE	TREES REQUIRED (1 DECIDUOUS TREES / 2000		SHRUBS REQUIRED	SHRUBS PROVIDED		DECIDUOUS	SHRUB			
AREA	FOOTAGE	SF, 1 EVERGREEN TREE /		(1 SHRUBS / 5 LF)		$ $ \cdot	BDW	MORMON TEA	EPHEDRA VIRIDIS	#5 CONT.	VERY LOW
		1500 SF)					BMS	BLUE MIST SPIREA	CARYOPTERIS X CLANDONENSIS 'BLUE MIST'	#5 CONT.	VERY LOW
AST AREA	35,647 SF	18 DECIDUOUS, 24	18 DECIDUOUS, 24	0	0		CLC	ALPINE CURRANT	RIBES ALPINUM	#5 CONT.	LOW
		EVERGREEN	EVERGREEN	, v	, , , , , , , , , , , , , , , , , , ,		FER	FERNBUSH	CHAMAEBATIARIA MILLEFOLIUM	#5 CONT.	VERY LOW
BUILDING	158 LF	0	0	32	32		PBS	PAWNEE BUTTES SANDCHERRY	PRUNUS BESSEYI 'PAWNEE BUTTES'	#5 CONT.	LOW
ERIMETER	100 LF	U	U	JZ	52		RAB	RABBITBRUSH	CHRYSOTHAMNUS NAUSEOSUS	#5 CONT.	VERY LOW
				·	•		RSA	RUSSIAN SAGE	PEROVSKIA ATRIPLICIFOLIA	#5 CONT.	LOW
						to the second se	GRASSES				
							HFG	HARDY FOUNTAIN GRASS	PENNISETUM ALOPECUROIDES 'HAMELN'	#1 CONT.	LOW
							MAG	MAIDEN GRASS	MISCANTHUS SINENSIS 'GRACILLIMUS'	#1 CONT.	LOW
							VMG	VARIEGATED MAIDEN GRASS	MISCANTHUS SINENSIS VARIEGATUS	#1 CONT.	LOW
											1

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LANDSCAPE AREA	LINEAR FEET/SQUARE FOOTAGE	TREES REQUIRED (1 DECIDUOUS TREES / 2000 SF, 1 EVERGREEN TREE / 1500 SF)	TREES PROVIDED	SHRUBS REQUIRED (1 SHRUBS / 5 LF)	SHRUBS PROVIDED
EAST AREA	35,647 SF	18 DECIDUOUS, 24 EVERGREEN	18 DECIDUOUS, 24 EVERGREEN	0	0
BUILDING PERIMETER	158 LF	0	0	32	32

QTY	SYM	COMMON NAME	BOTANICAL NAME	SIZE	WATER US
	DECIDUOUS	TREES			ł
	CEL	WESTERN HACKBERRY	CELTIS OCCIDENTALIS	2" CAL. B&B	LOW
	IMP	IMPERIAL HONEYLOCUST	GLEDITSIA TRIACANTHOS INERMIS IMPERIAL	2" CAL. B&B	LOW
	QUR	ENGLISH OAK	QUERCUS ROBUR	2" CAL. B&B	LOW
	SWO	SWAMP WHILE OAK	QUERCUS BICOLOR	2" CAL. B&B	LOW
	ORNAMENTA				
		CHANTICLEER PEAR	PYRUS CALLERYANA 'CHANTICLEER'	2" CAL. B&B	MODERATE
	DOW	WASHINGTON HAWTHORN	CRATAEGUS PHAENOPYRUM	2" CAL. B&B	LOW
	GMT	TATARIAN MAPLE	ACER TATARICUM	2" CAL. B&B	LOW
	ТСН	THORNLESS COCKSPUR HAWTHORN	CRATAEGUS CRUS-GALLI INERMIS	2" CAL. B&B	LOW
	1011			Z OAL DOD	
	EVERGREEN	TREES/LARGE SHRUBS			
	AUS	AUSTRIAN PINE	PINUS NIGRA	6'-12' HT. B&B	LOW
	BOP	BOSNIAN PINE	PINUS HELDREICHII VAR. LEUCODERMIS	6'-12' HT. B&B	LOW
	PIN	PINON PINE	PINUS EDULIS	6'-12' HT. B&B	LOW
	PON	PONDEROSA PINE	PINUS PONDEROSA	6'-12' HT. B&B	LOW
	EVERGREEN/I	BROADLEAF EVERGREEN SHRUBS			
	BCH	BLUE CHIP JUNIPER	JUNIPERUS HORIZONTALIS 'BLUE CHIP'	#5 CONT.	LOW
	BSG	SPANISH GOLD BROOM	CYTISUS PURGAN 'SPANSIH GOLD'	#5 CONT.	LOW
	BUF	BUFFALO JUNIPER	JUNIPERUS SABINA 'BUFFALO'	#5 CONT.	LOW
	MPA	PANCHITO MANZANITA	ARCTOSTAPHYLOS 'PANCHITO'	#5 CONT.	LOW
	DECIDUOUS S	SHRUB			
	BDW	MORMON TEA	EPHEDRA VIRIDIS	#5 CONT.	VERY LOW
	BMS	BLUE MIST SPIREA	CARYOPTERIS X CLANDONENSIS 'BLUE MIST'	#5 CONT.	VERY LOW
	CLC	ALPINE CURRANT	RIBES ALPINUM	#5 CONT.	LOW
		FERNBUSH	CHAMAEBATIARIA MILLEFOLIUM	#5 CONT.	VERY LOW
	FER	FERINDUOR			
	FER PBS	PAWNEE BUTTES SANDCHERRY	PRUNUS BESSEYI 'PAWNEE BUTTES'	#5 CONT.	LOW
				#5 CONT. #5 CONT.	LOW VERY LOW
	PBS	PAWNEE BUTTES SANDCHERRY	PRUNUS BESSEYI 'PAWNEE BUTTES'		
	PBS RAB RSA	PAWNEE BUTTES SANDCHERRY RABBITBRUSH	PRUNUS BESSEYI 'PAWNEE BUTTES' CHRYSOTHAMNUS NAUSEOSUS	#5 CONT.	VERY LOW
	PBS RAB	PAWNEE BUTTES SANDCHERRY RABBITBRUSH	PRUNUS BESSEYI 'PAWNEE BUTTES' CHRYSOTHAMNUS NAUSEOSUS	#5 CONT.	VERY LOW
	PBS RAB RSA GRASSES	PAWNEE BUTTES SANDCHERRY RABBITBRUSH RUSSIAN SAGE	PRUNUS BESSEYI 'PAWNEE BUTTES' CHRYSOTHAMNUS NAUSEOSUS PEROVSKIA ATRIPLICIFOLIA	#5 CONT. #5 CONT.	VERY LOW LOW

AMEN	NITY SCHEDULE				
ITEM	DESCRIPTION	MANUFACTURER	MODEL	COLOR/FINISH	NOTES
$\langle 1 \rangle$	BENCH	TBD	TBD	POWDERCOAT BLACK	MOUNT PER MANUFACTURER SPECIFICATIONS
	FENCE	AMERISTAR	IMPASSE II w/ PRIVACY SLATS	POWDERCOAT BLACK	MOUNT PER MANUFACTURER SPECIFICATIONS

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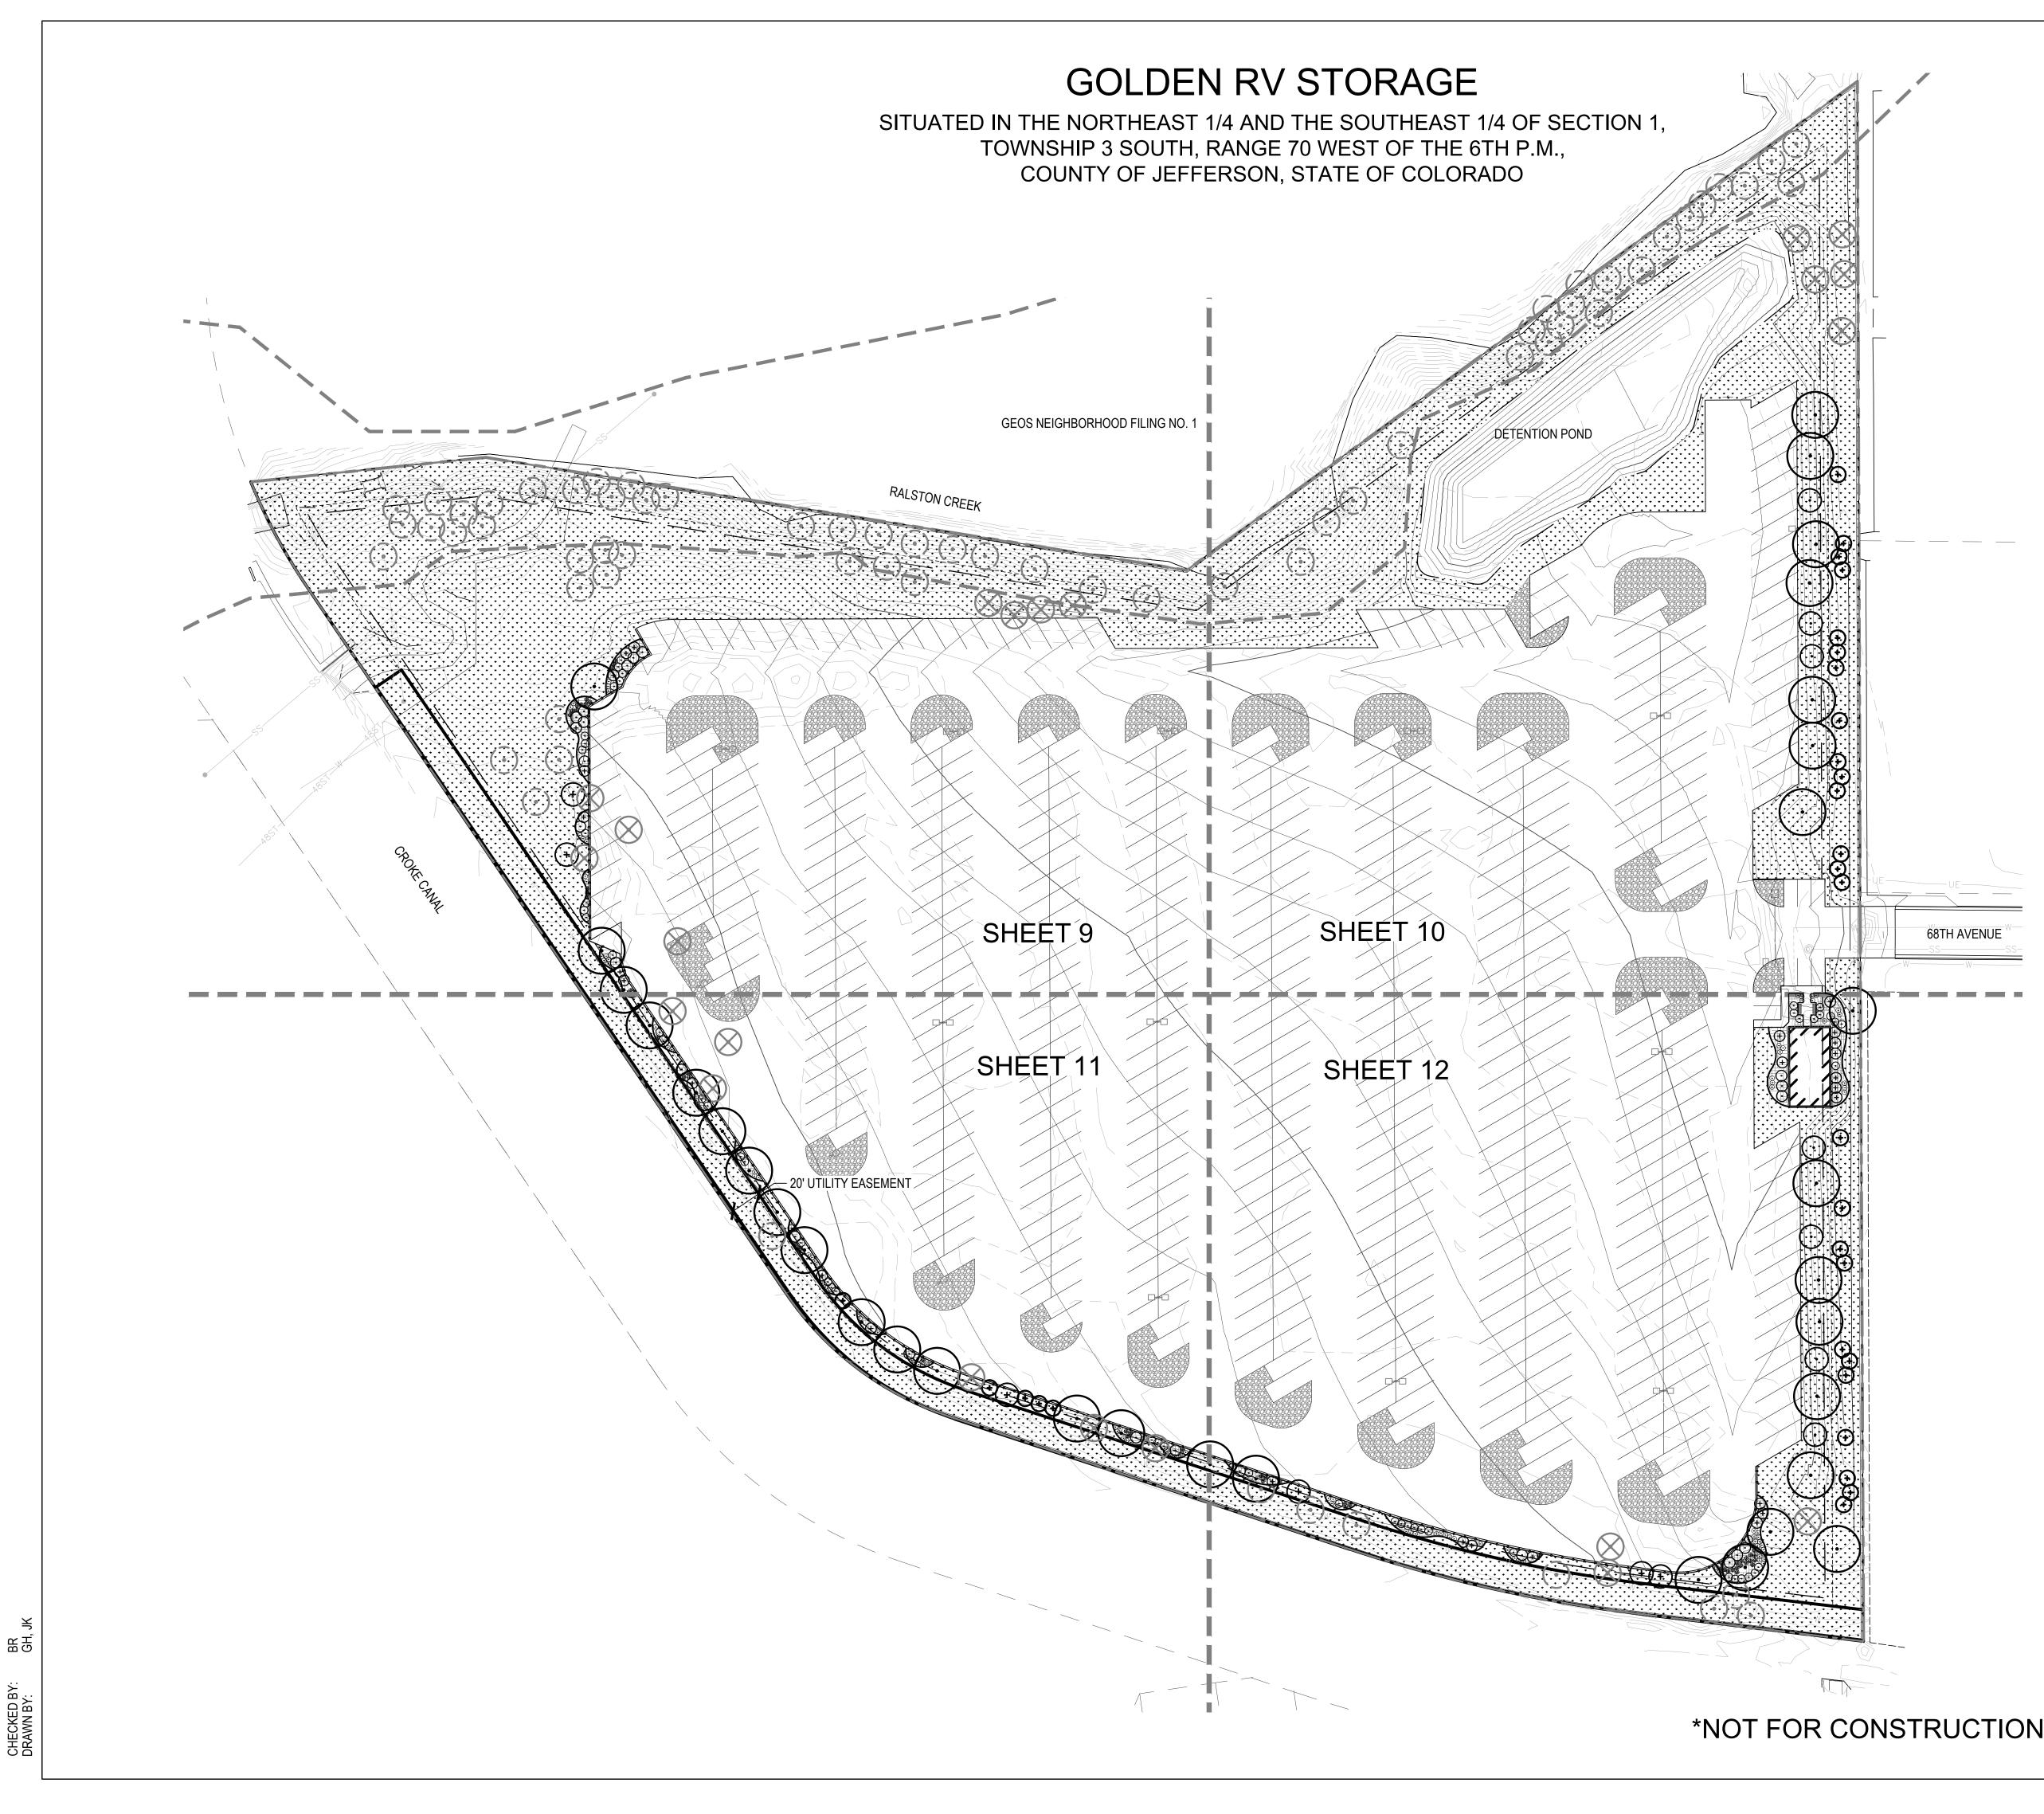
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DATE: <u>12/03/21 - 1ST SUB</u>

SHEET TITLE: LANDSCAPE NOTES

***NOT FOR CONSTRUCTION**

SHEET 5 OF 16





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LEGEND:	
\bigcirc	CANOPY TREES
\bigotimes	EXISTING TREE TO BE REMOVED
\odot	EXISTING TREE TO REMAIN
\odot	ORNAMENTAL TREES
+++++++++++++++++++++++++++++++++++++++	EVERGREEN TREES
(+) (+) (+)	EVERGREEN SHRUBS
\odot	DECIDUOUS SHRUBS
× Kongo	ORNAMENTAL GRASSES
	LANDSCAPE BED (LOW HYDROZONE)
	NATIVE SEED (VERY LOW HYDROZONE)
	COBBLE

ORNAMENTAL GRASSES
LANDSCAPE BED (LOW HYDROZONE)
NATIVE SEED (VERY LOW HYDROZONE
COBBLE

PROPERTY LINE

NOTES: 1. ALL PROPOSED PLANTS SHALL BE LOW OR VERY LOW WATER USE.


 ••••••
 FENCE-RE:AMENITY SCHEDULE
 ON SHEET 5

C Ŷ

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SHEET 6 OF 16



¥ BR, GH, CHECKED BY: DRAWN BY:
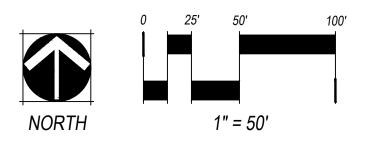
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 \bigotimes EXISTING TREE TO BE REMOVED EXISTING TREE TO REMAIN (\cdot)

TREE MITIGATION TABLE

LEGEND

TREES TO BE REMOVED	22
TREES TO BE PRESERVED	115

NOTE: TREE SURVEY PROVIDED BY SCOTT GRIMES, COLORADO TREE CONSULTANTS - 303.720.8170

HE FOLLOWING TREE PROTECTION SPECIFICATIONS SHOULD BE FOLLOWED TO THE MAXIMUM XTENT FEASIBLE FOR ALL PROJECTS WITH PROTECTED EXISTING TREES:


- PRIOR TO AND DURING CONSTRUCTION, BARRIERS SHALL BE ERECTED AROUND ALL TECTED EXISTING TREES WITH SUCH BARRIERS TO BE OF ORANGE FENCING A IIMUM OF FOUR FEET IN HEIGHT. SECURED WITH METAL T-POSTS. NO CLOSER THAN SI FEET FROM THE TRUNK OR ONE FOOT FOR EVERY INCH OF DIAMETER WHICHEVER IS GREATER (FOR EXAMPLE. A TEN-INCH DIAMETER TREE WILL HAVE A FENCE NO CLOSER THAN TEN FEET FROM THE TRUNK). THERE SHALL BE NO STORAGE OR MOVEMENT OF EQUIPMENT, MATERIAL, DEBRIS OR FILL WITHIN THE FENCED TREE PROTECTION ZONE UNLESS PREVIOUSLY APPROVED BY THE DIRECTOR
- DURING THE CONSTRUCTION STAGE OF DEVELOPMENT, THE APPLICANT SHALL PREVENT THE CLEANING OF EQUIPMENT OR MATERIAL OR THE STORAGE AND DISPOSAL OF WASTE MATERIAL SUCH AS PAINTS, OILS, SOLVENTS, ASPHALT, CONCRETE, MOTOR OIL OR ANY OTHER MATERIAL HARMFUL TO THE LIFE OF A TREE WITHIN THE FENCED TREE PROTECTION ZONE.
- 3. NO DAMAGING ATTACHMENT, WIRES, SIGNS OR PERMITS MAY BE FASTENED TO ANY PROTECTED TREE
- 4. LARGE PROPERTY AREAS CONTAINING PROTECTED TREES AND SEPARATED FROM CONSTRUCTION OR LAND CLEARING AREAS, ROAD RIGHTS-OF-WAY AND UTILITY EASEMENTS MAY BE "RIBBONED OFF," RATHER THAN ERECTING PROTECTIVE FENCING EASEMENTS MAY BE "RIBBONED OFF," RATHER THAN ERECTING PROTECTIVE FENCING AROUND EACH TREE. THIS MAY BE ACCOMPLISHED BY PLACING METAL TPOST STAKES A MAXIMUM OF 50 FEET APART AND TYING RIBBON OR ROPE FROM STAKE-TO-STAKE ALONG THE OUTSIDE PERIMETERS OF SUCH AREAS BEING CLEARED. THE INSTALLATION OF UTILITIES, IRRIGATION LINES OR ANY UNDERGROUND FIXTURE WITHIN THE FENCE TREE PROTECTION ZONE SHALL BE ACCOMPLISHED BY BORING UNDER THE ROOT SYSTEM OF PROTECTED EXISTING TREES AT A MINIMUM DEPTH OF 24 INCHES.

RV STORAGE	
GOLDEN	SITE PLAN CITY OF ARVADA, CO

OWNER: CHELTON LLC PO BOX 460010 FORT LAUDERDALE, FL 33346

NOT FOR CONSTRUCTION


DATE: <u>12/03/21 - 1ST SUB</u>

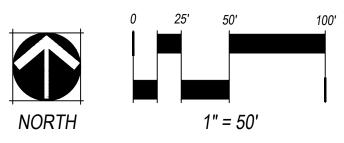




SHEET TITLE: TREE MITIGATION PLAN

SHEET 7 OF 16

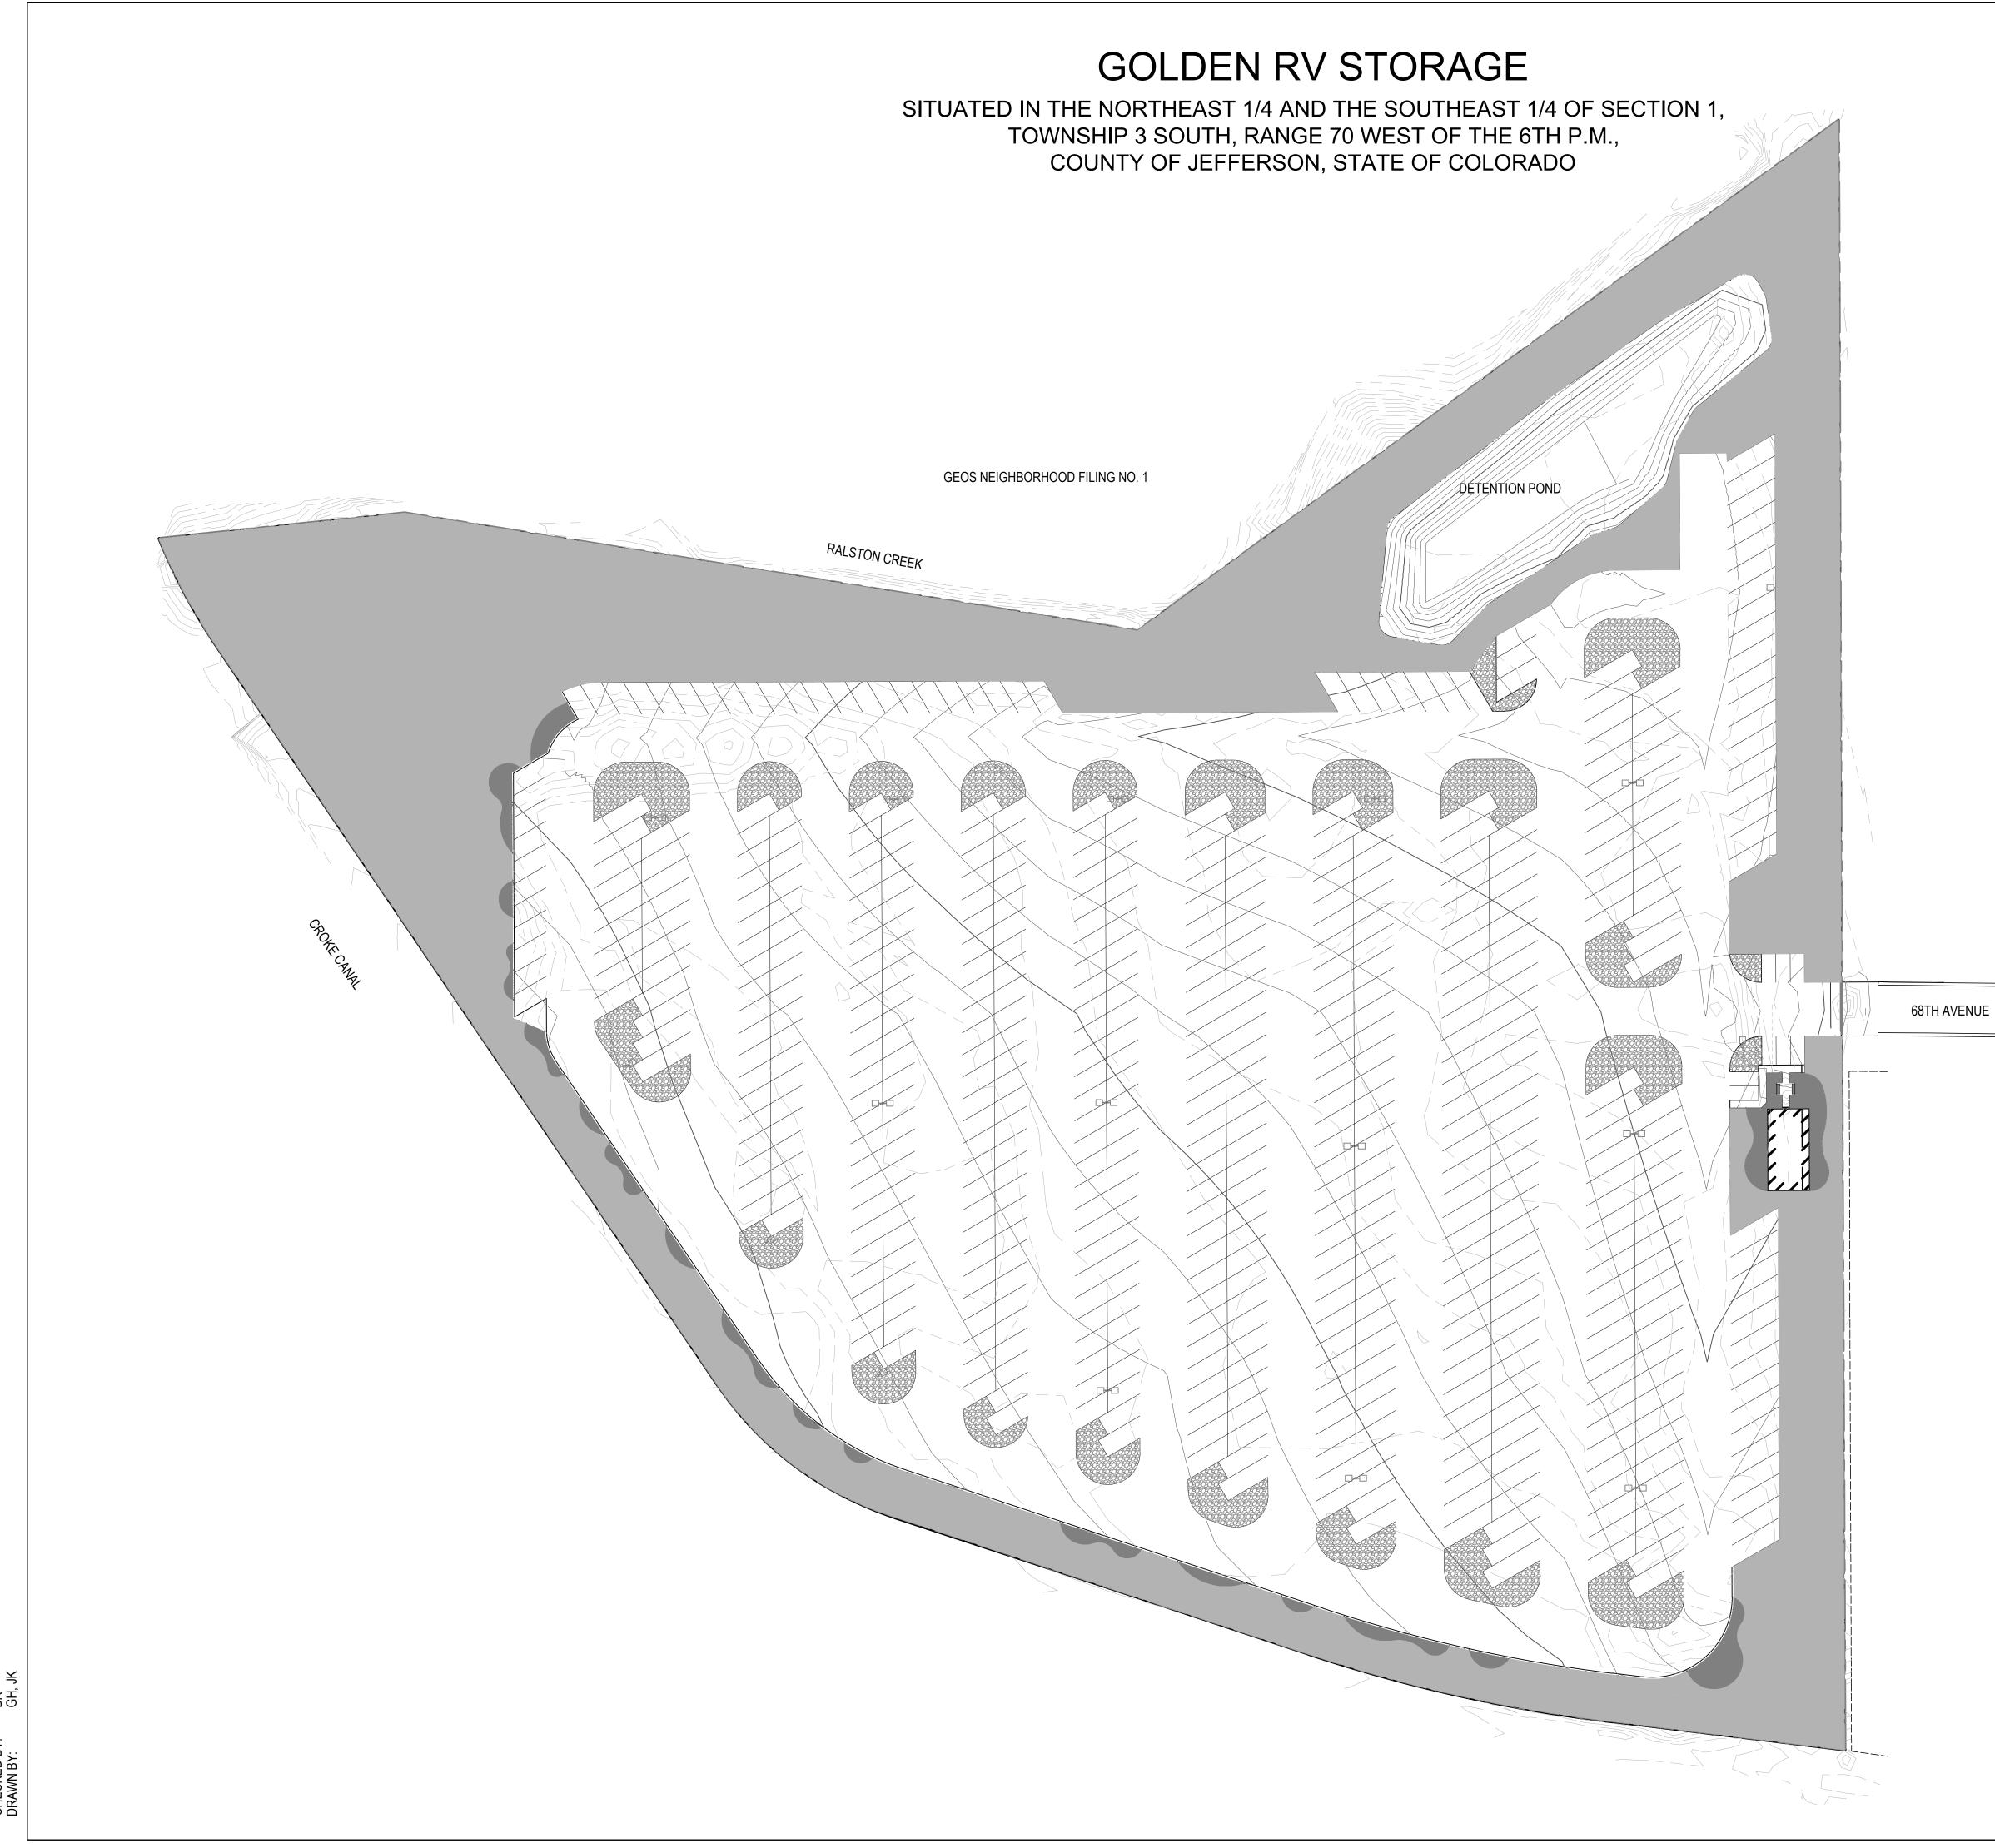





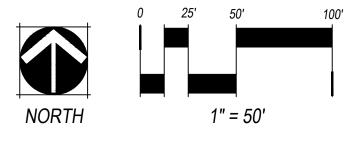


***NOT FOR CONSTRUCTION**

CALL UNCC TWO WORKING DAYS BEFORE YOU DIG 1-800-922-1987 534-6700 METRO DENVER AREA UTILITY NOTIFICATION CENTER OF COLORADO

DATE: <u>12/03/21 - 1ST SUB</u>


NOT FOR CONSTRUCTION

OWNER: CHELTON LLC PO BOX 460010 FORT LAUDERDALE, FL 33346

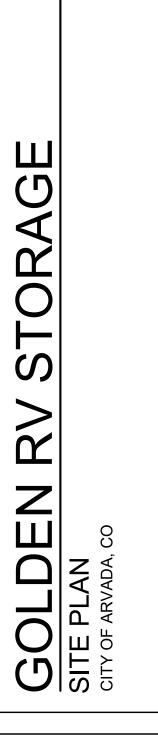

LEGEND


ROCK COBBLE (NON-IRRIGATED)

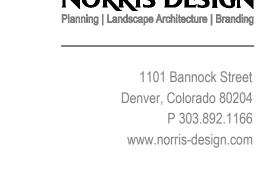

D LOW (7"-15" PER YEAR)

D VERY LOW (0"-7" PER YEAR)

NORRIS DESIGN Planning | Landscape Architecture | Branding

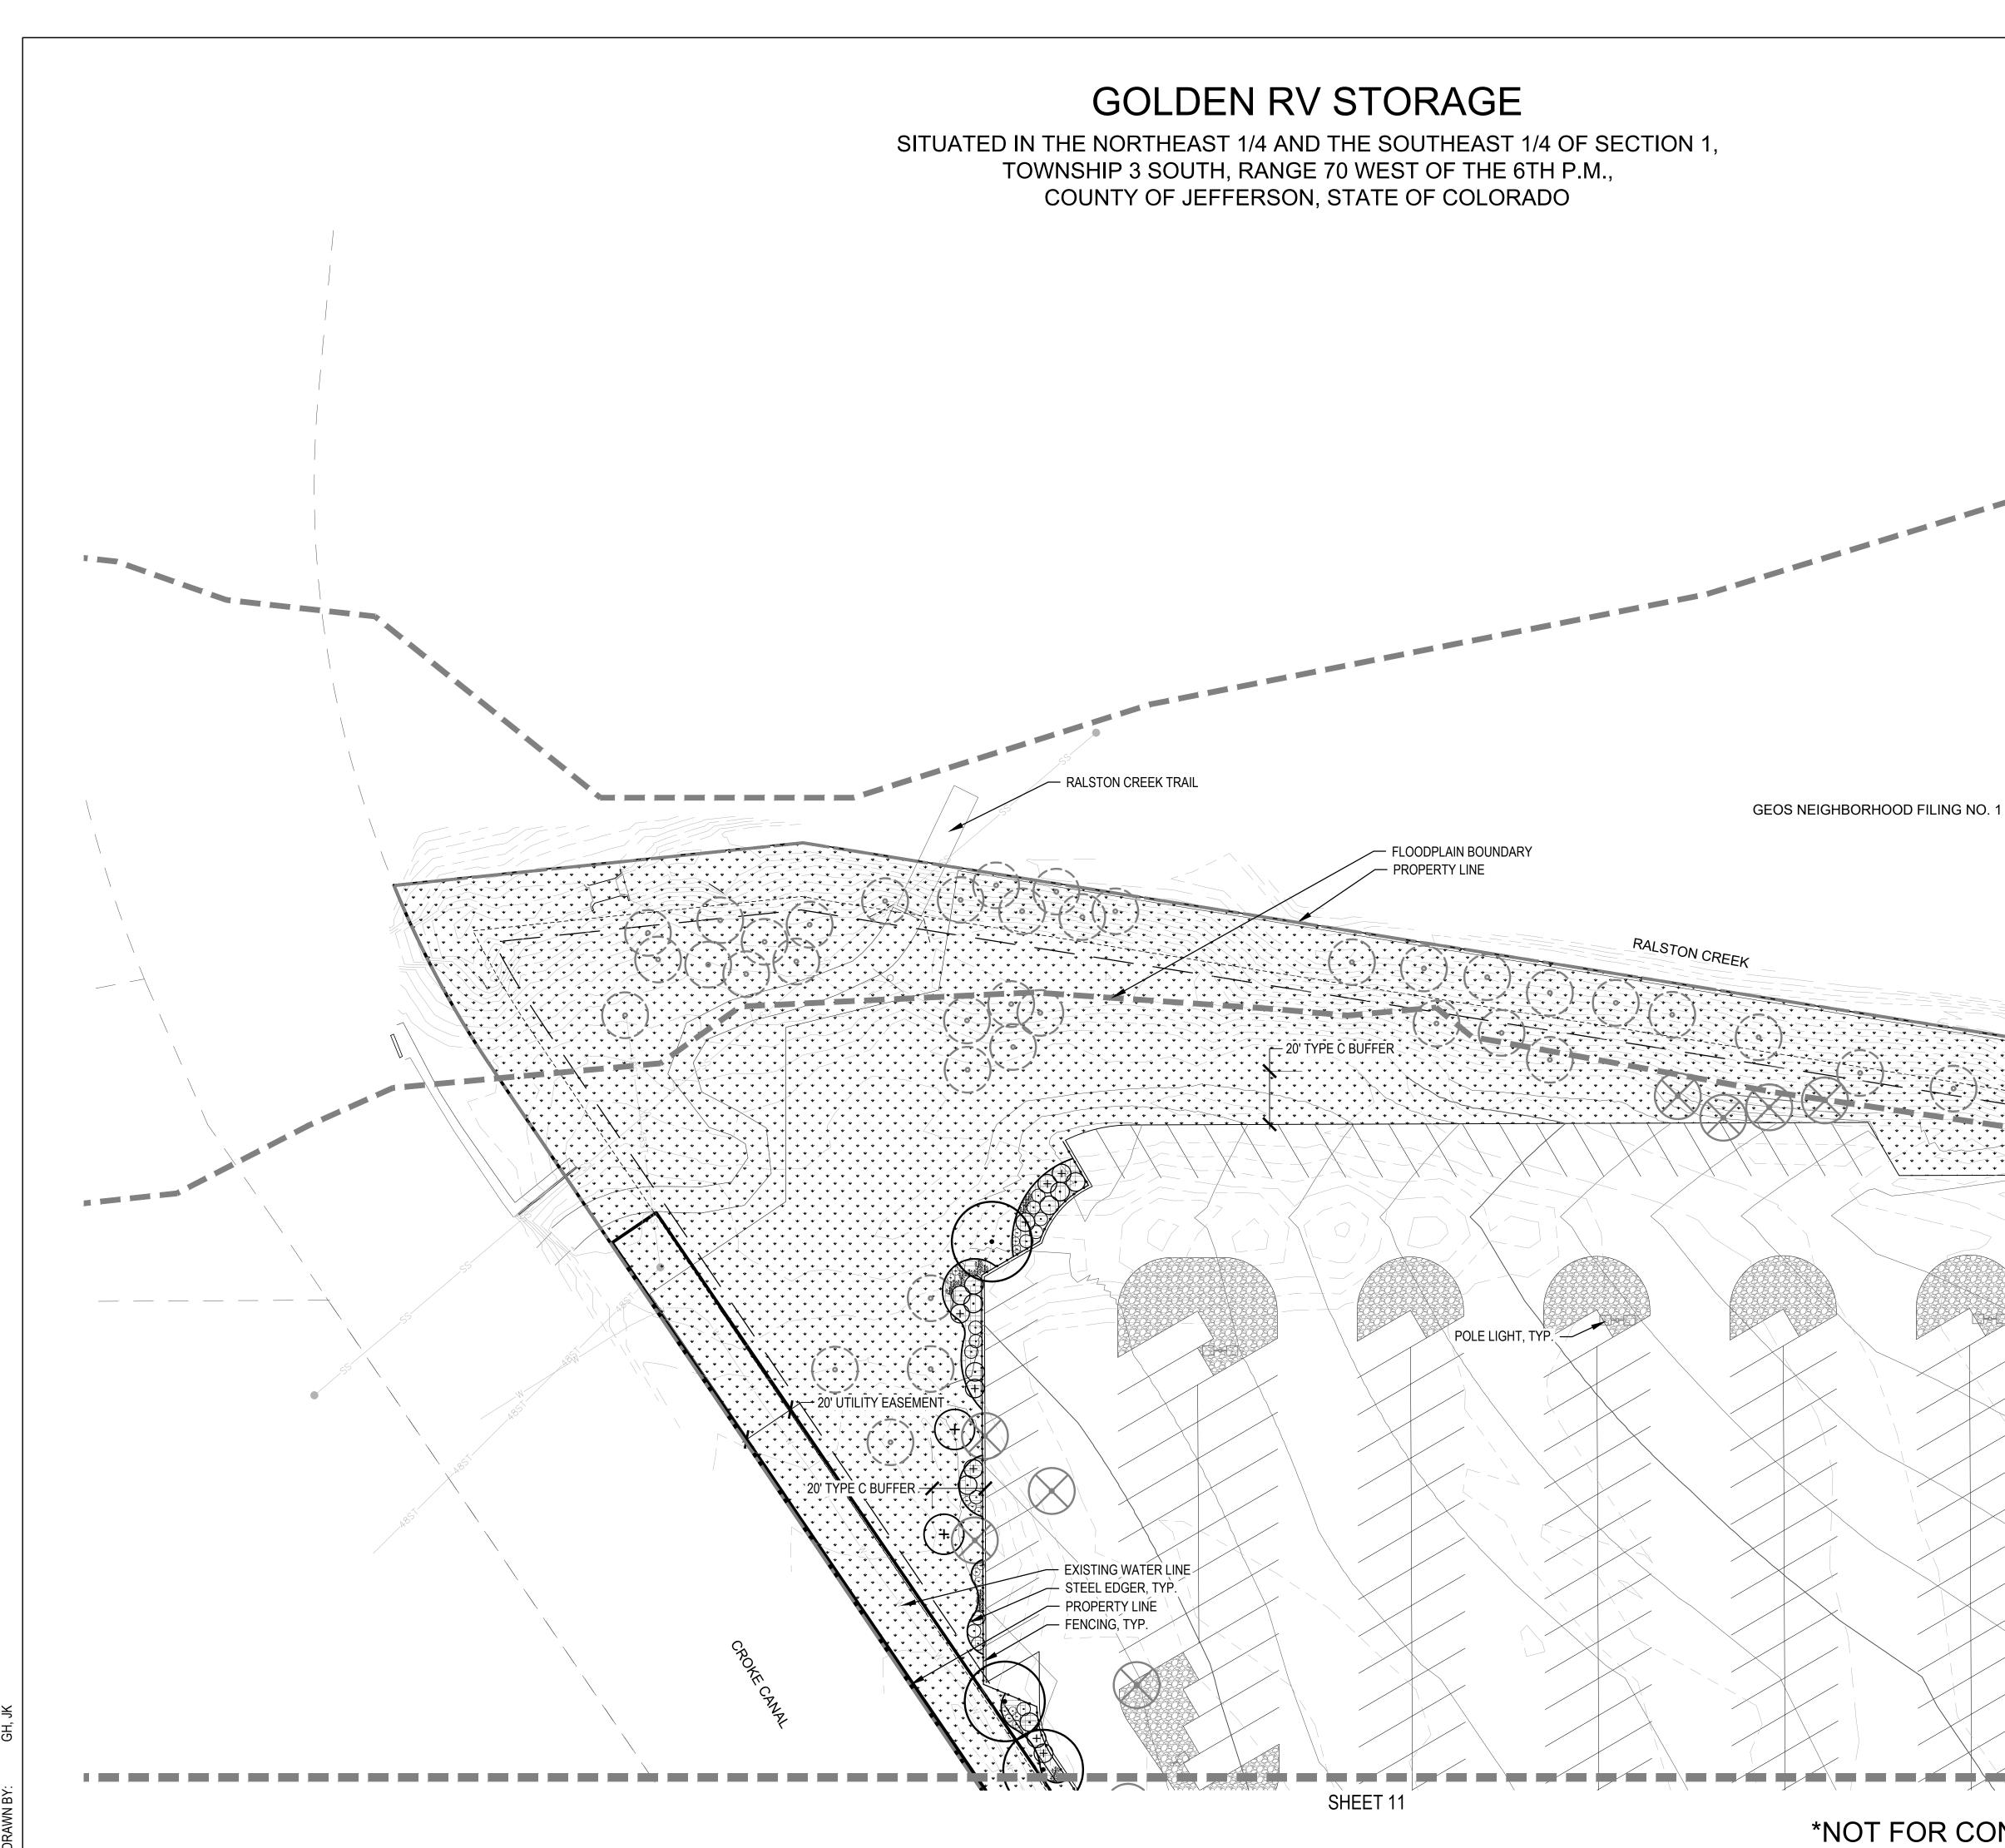



В


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·	CANOPY TREES
	EXISTING TREE TO BE REMOVED
0	EXISTING TREE TO REMAIN
(\cdot)	ORNAMENTAL TREES
++++++	EVERGREEN TREES
(+) (+) (+)	EVERGREEN SHRUBS
\bigcirc	DECIDUOUS SHRUBS
*	ORNAMENTAL GRASSES
	LANDSCAPE BED (LOW HYDROZONE)
· · · · · · · · · · · · · · · · · · ·	NATIVE SEED (VERY LOW HYDROZONE)
	COBBLE
	PROPERTY LINE
	FENCE, RE: AMENITY SCHEDULE ON SHEET 5
NOTES:	

NOTES: 1. ALL PROPOSED PLANTS SHALL BE LOW OR VERY LOW WATER USE.






OWNER:
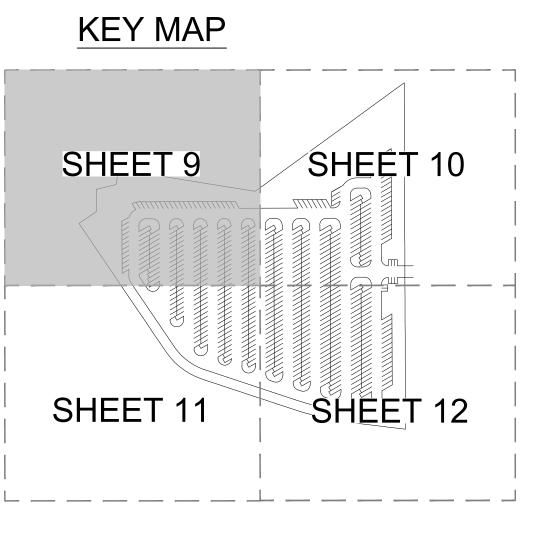
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DATE: <u>12/03/21 - 1ST SUB</u>

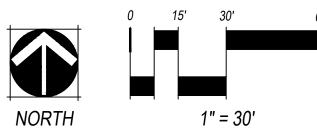


CALL UNCC TWO WORKING DAYS BEFORE YOU DIG 1-800-922-1987 534-6700 METRO DENVER AREA UTILITY NOTIFICATION CENTER OF COLORADO



***NOT FOR CONSTRUCTION**


10

SHEET 9 OF 16

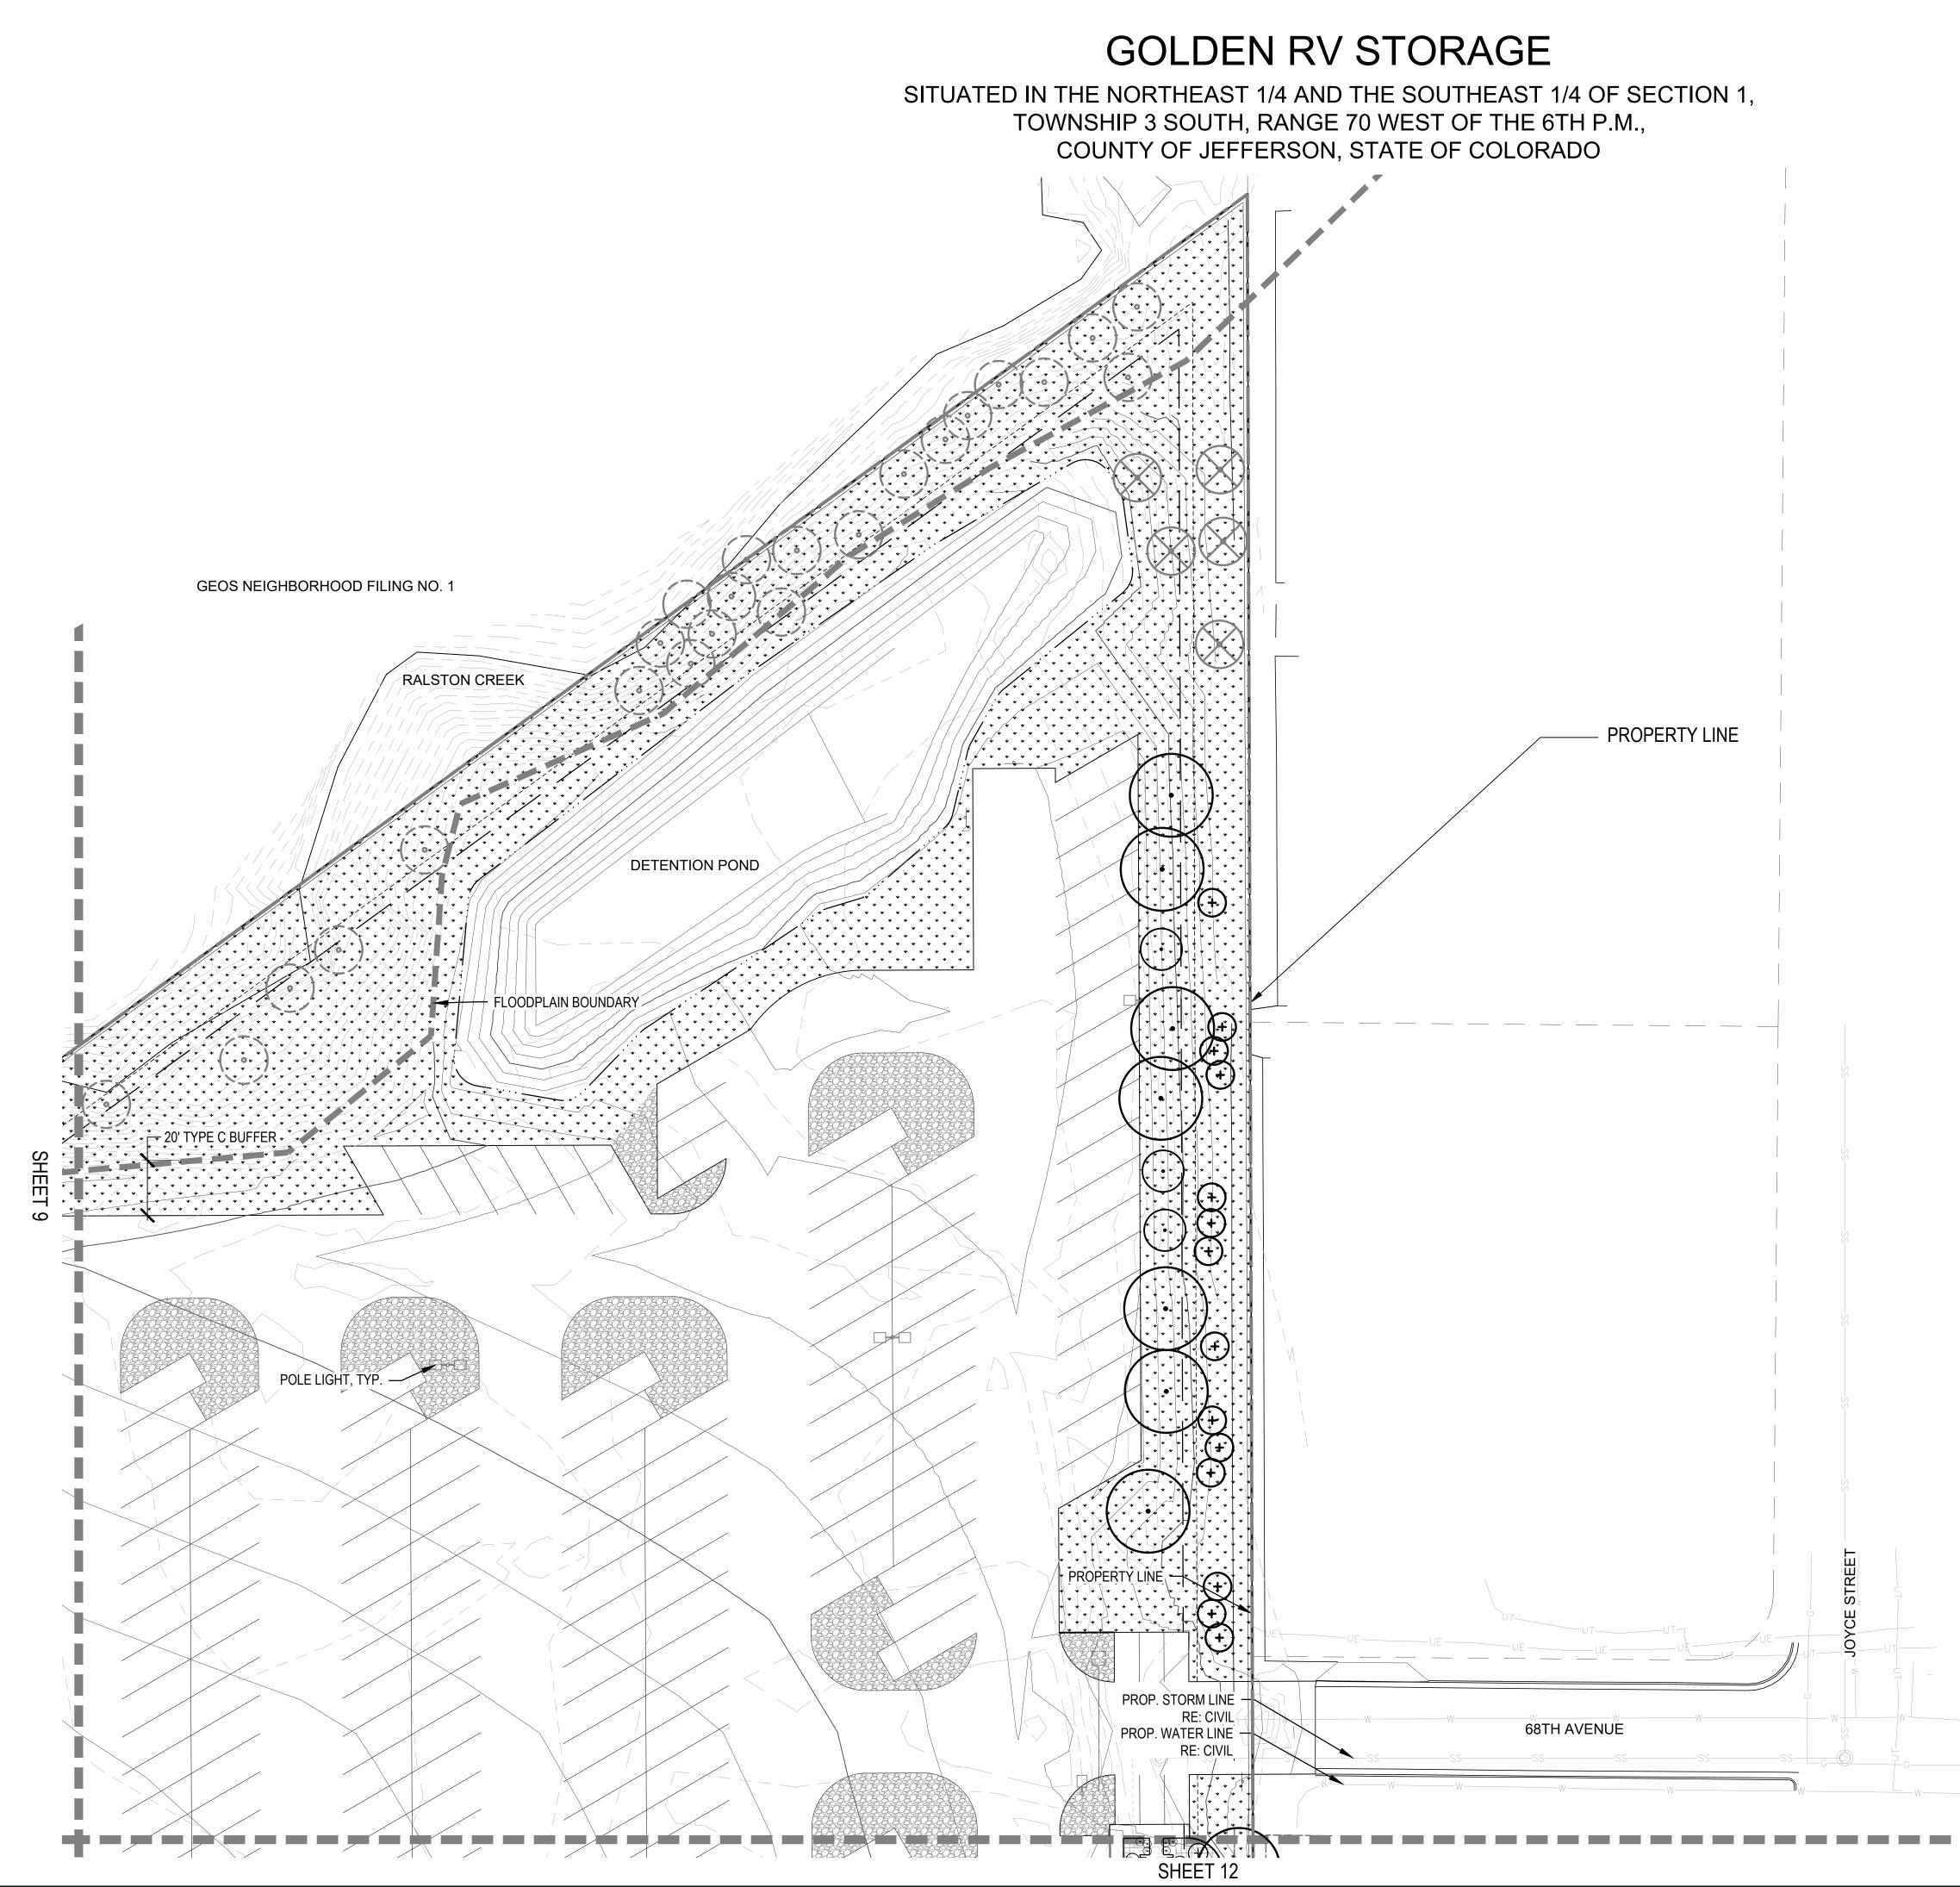



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CANOPY TREES

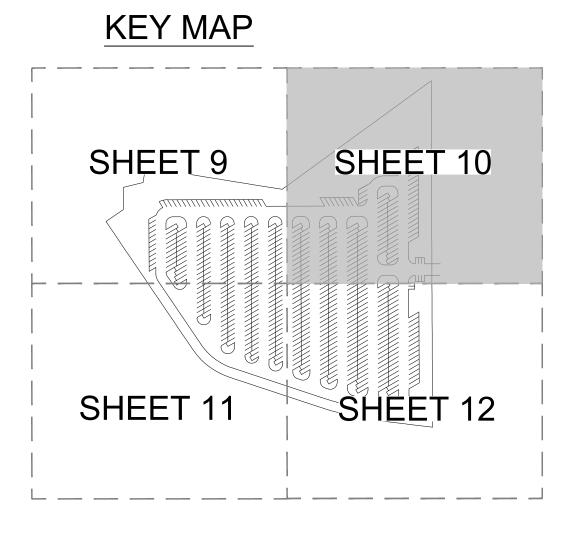EXISTING TREE TO BE REMOVED

EXISTING TREE TO REMAIN

ORNAMENTAL TREES

EVERGREEN TREES

EVERGREEN SHRUBS

DECIDUOUS SHRUBS

LANDSCAPE BED

NATIVE SEED

COBBLE

PROPERTY LINE

••••••• FENCE, RE: AMENITY

1. ALL PROPOSED PLANTS SHALL BE LOW

OR VERY LOW WATER USE.

(LOW HYDROZONE)

ORNAMENTAL GRASSES

(VERY LOW HYDROZONE)

SCHEDULE ON SHEET 5

LEGEND:

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NOTES:

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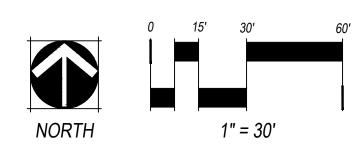
OWNER:

CHELTON LLC PO BOX 460010 FORT LAUDERDALE, FL 33346

NOT FOR CONSTRUCTION

DATE: <u>12/03/21 - 1ST SUB</u>

***NOT FOR CONSTRUCTION**






SHEET TITLE: LANDSCAPE PLAN


SHEET10 OF 16

GOLDEN RV STORAGE SITUATED IN THE NORTHEAST 1/4 AND THE SOUTHEAST 1/4 OF SECTION 1, TOWNSHIP 3 SOUTH, RANGE 70 WEST OF THE 6TH P.M., COUNTY OF JEFFERSON, STATE OF COLORADO

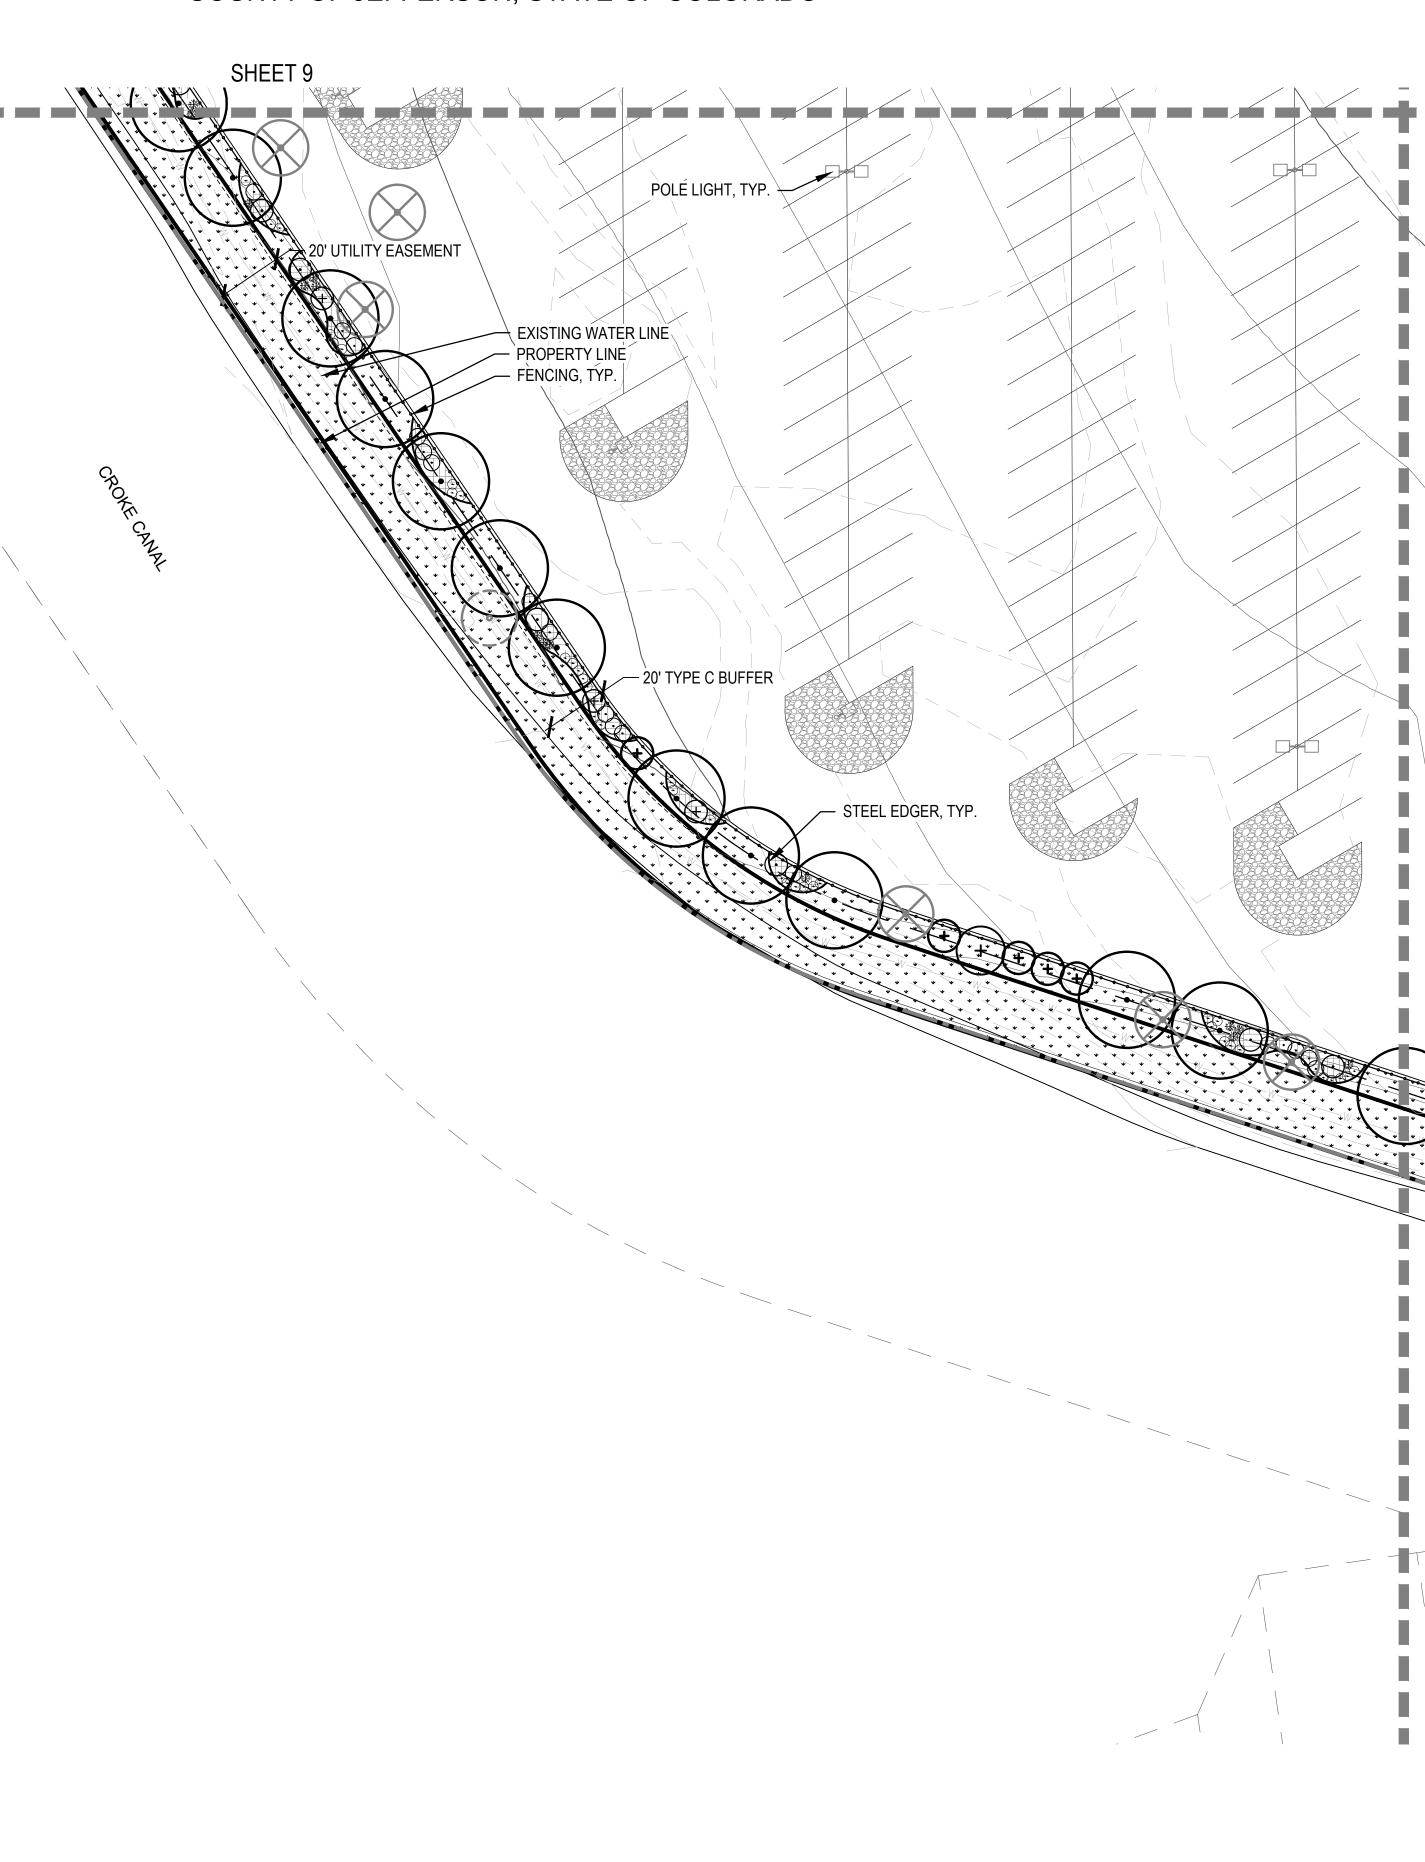




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EVERGREEN SHRUBS DECIDUOUS SHRUBS ORNAMENTAL GRASSES LANDSCAPE BED (LOW HYDROZONE) NATIVE SEED (VERY LOW HYDROZONE) COBBLE

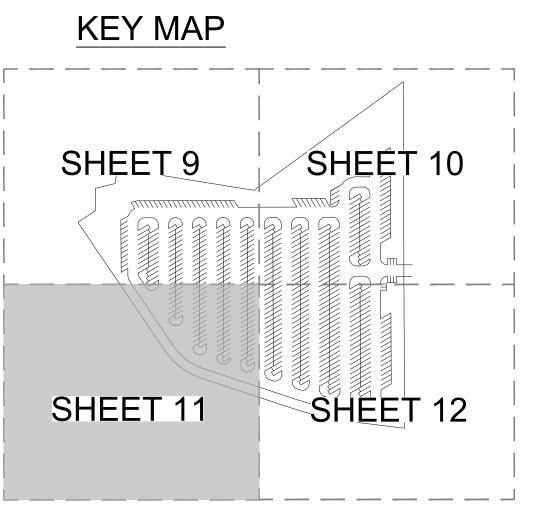FENCE, RE: AMENITY SCHEDULE ON SHEET 5


NOTES: 1. ALL PROPOSED PLANTS SHALL BE LOW OR VERY LOW WATER USE.

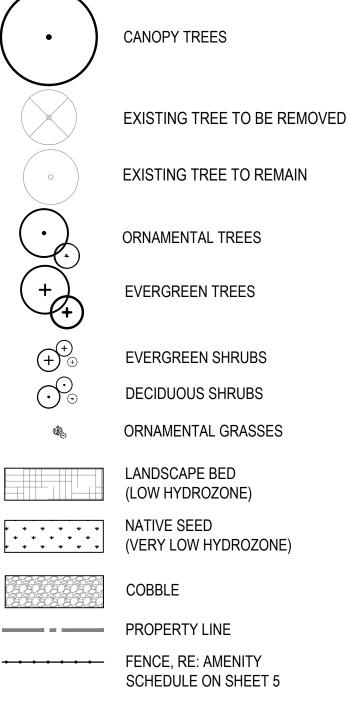

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NOT FOR CONSTRUCTION

DATE: <u>12/03/21 - 1ST SUB</u>

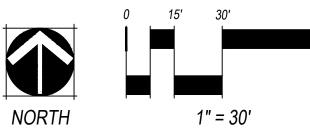


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***NOT FOR CONSTRUCTION**

12

SHEET11OF 16




GOLDEN RV STORAGE

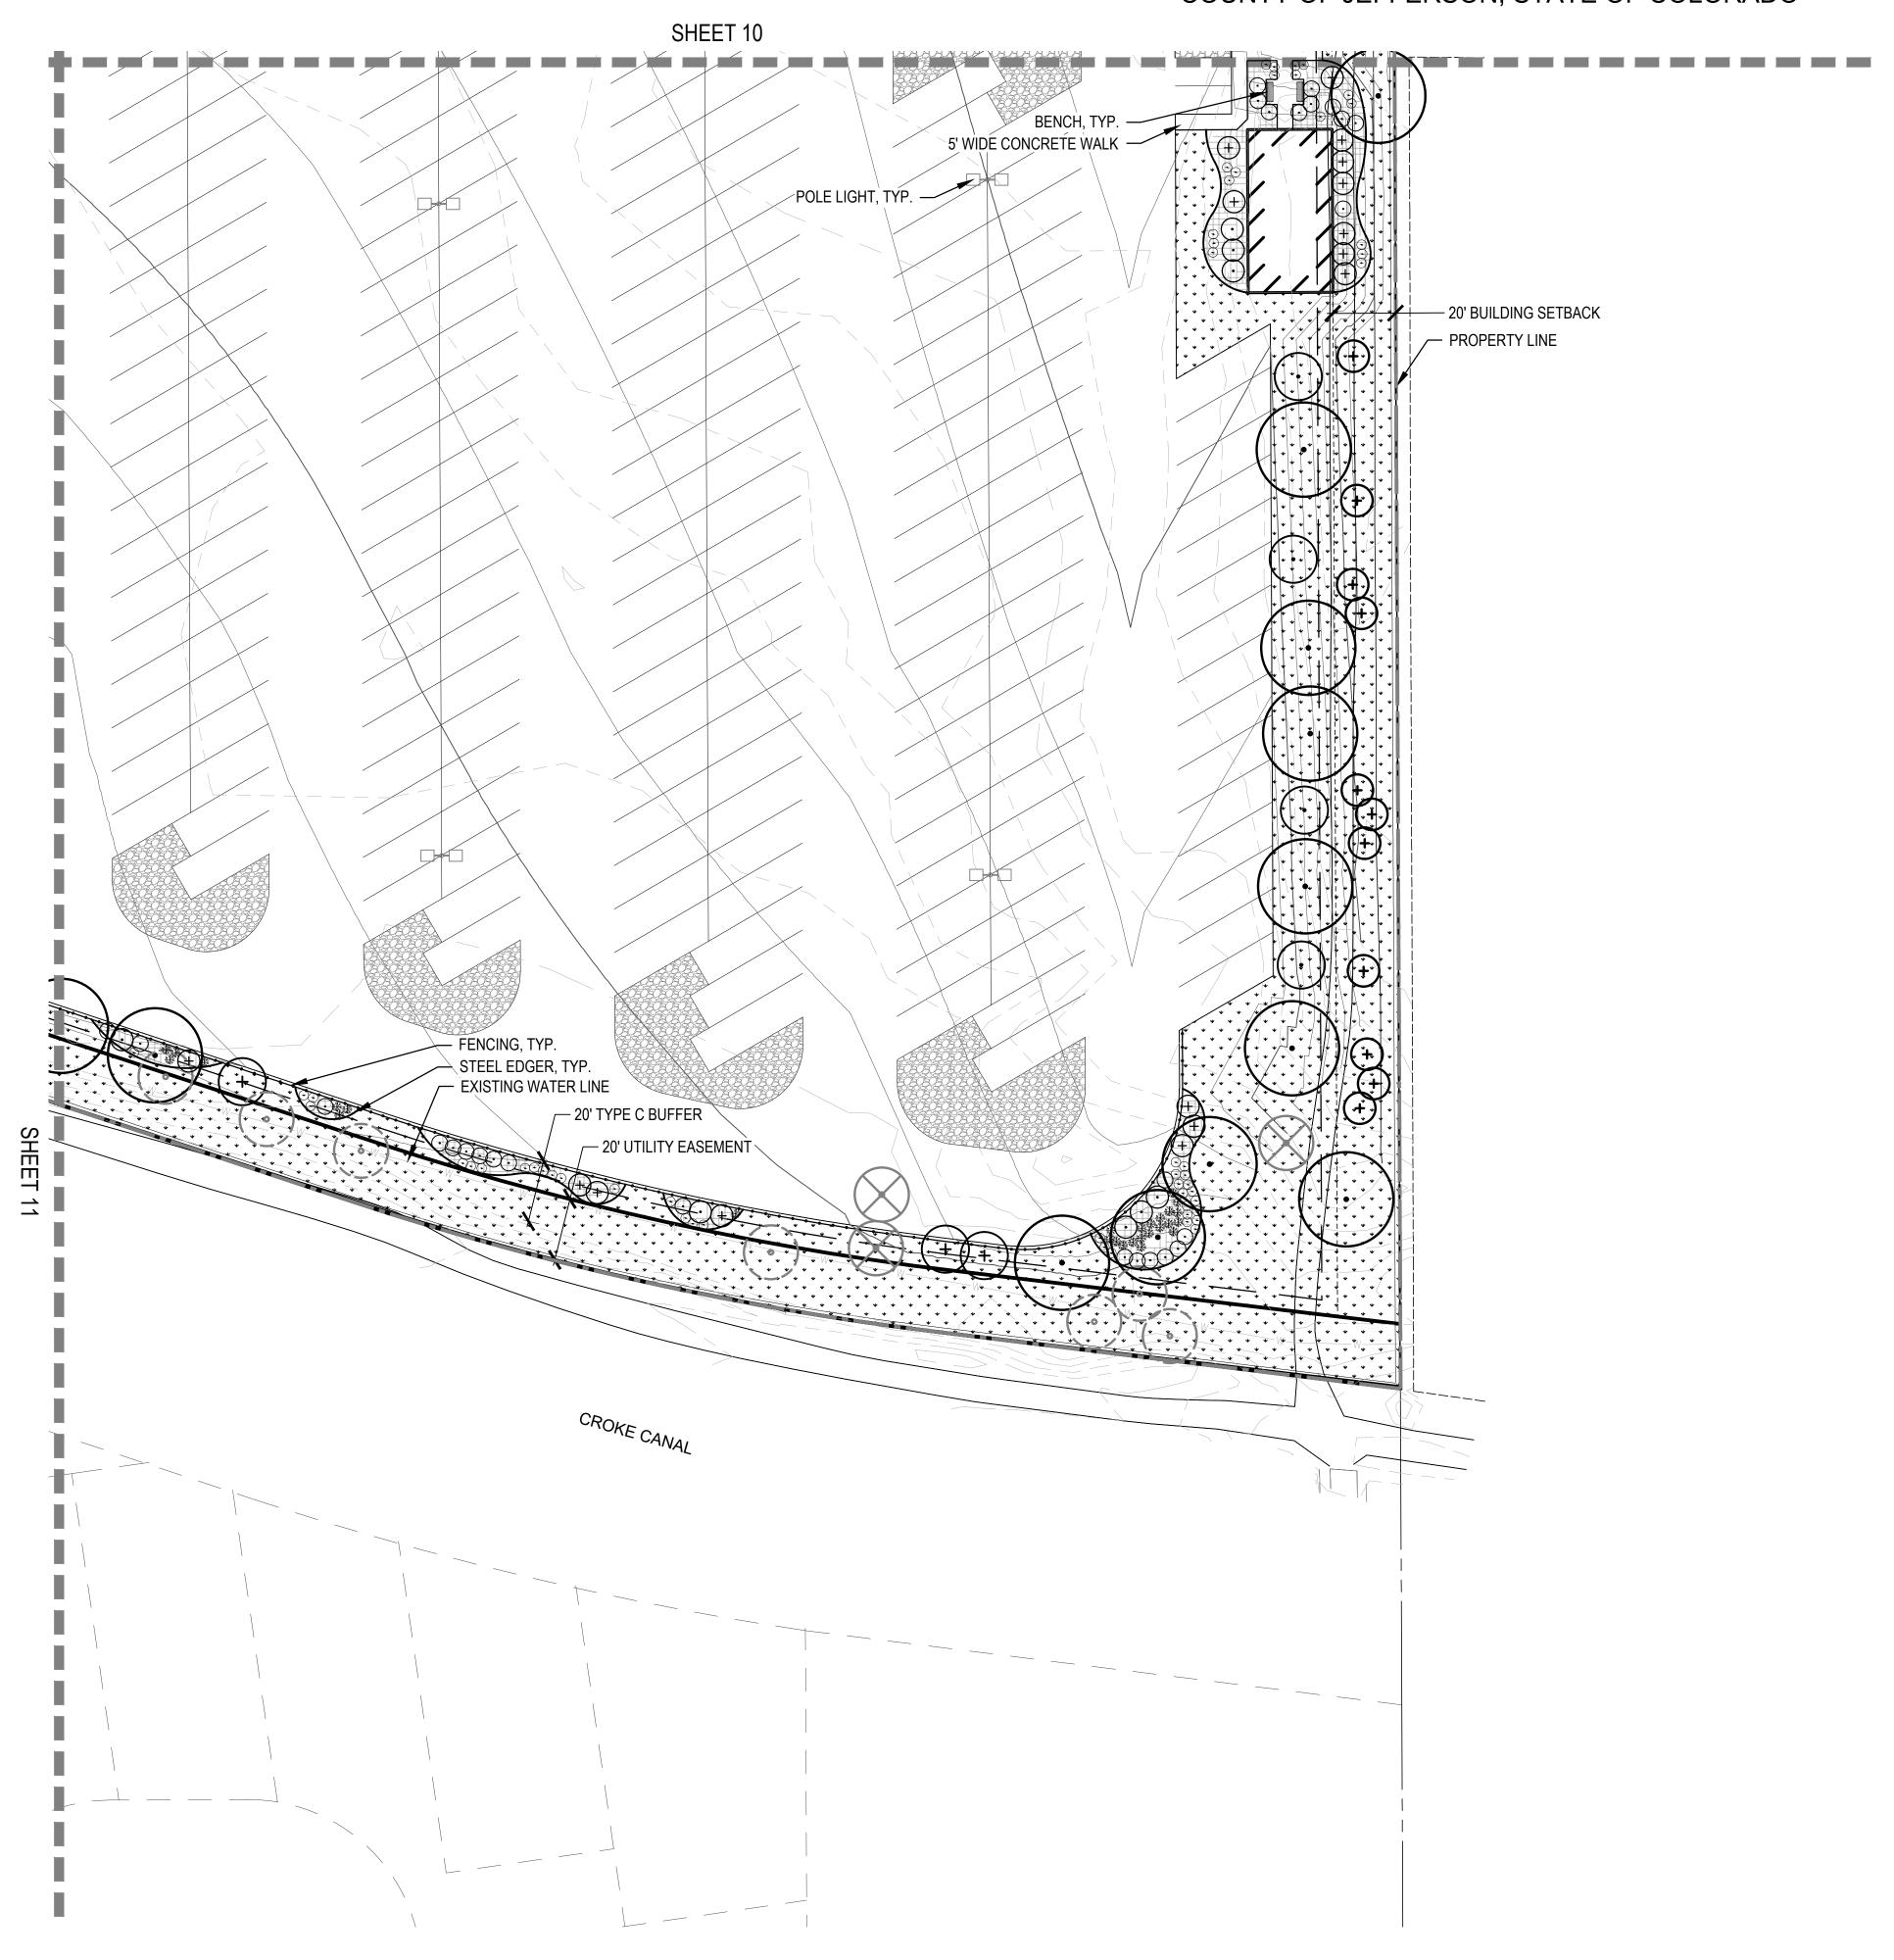
SITUATED IN THE NORTHEAST 1/4 AND THE SOUTHEAST 1/4 OF SECTION 1, TOWNSHIP 3 SOUTH, RANGE 70 WEST OF THE 6TH P.M., COUNTY OF JEFFERSON, STATE OF COLORADO



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LEGEND:

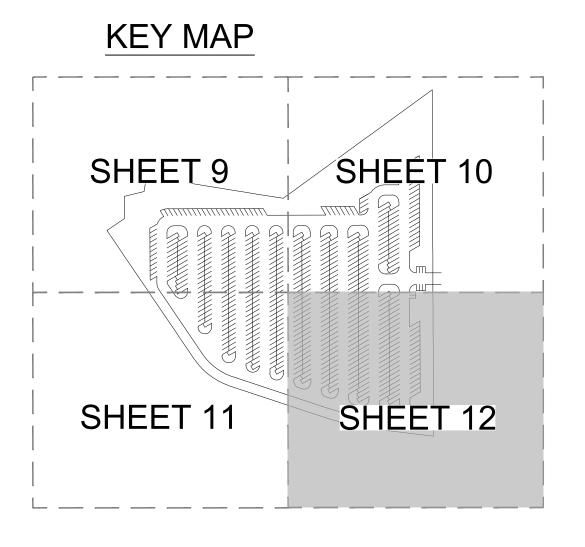

NOTES:

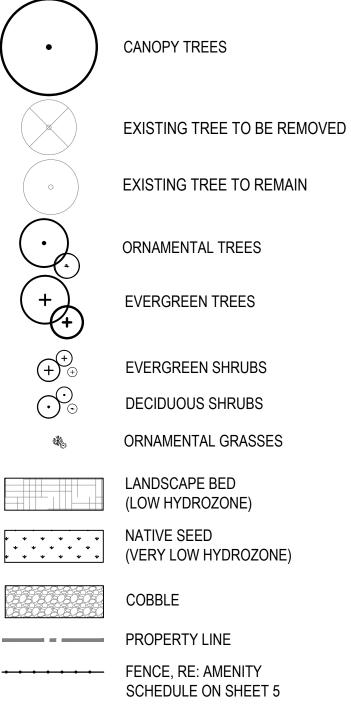
1. ALL PROPOSED PLANTS SHALL BE LOW OR VERY LOW WATER USE.



OWNER: CHELTON LLC PO BOX 460010 FORT LAUDERDALE, FL 33346

NOT FOR CONSTRUCTION

DATE: <u>12/03/21 - 1ST SUB</u>

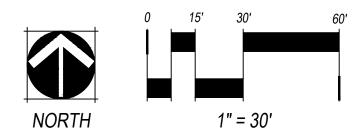


SHEET TITLE: LANDSCAPE PLAN

***NOT FOR CONSTRUCTION**


CALL UNCC TWO WORKING DAYS BEFORE YOU DIG 1-800-922-1987 534-6700 METRO DENVER AREA UTILITY NOTIFICATION CENTER OF COLORADO

SHEET12OF 16

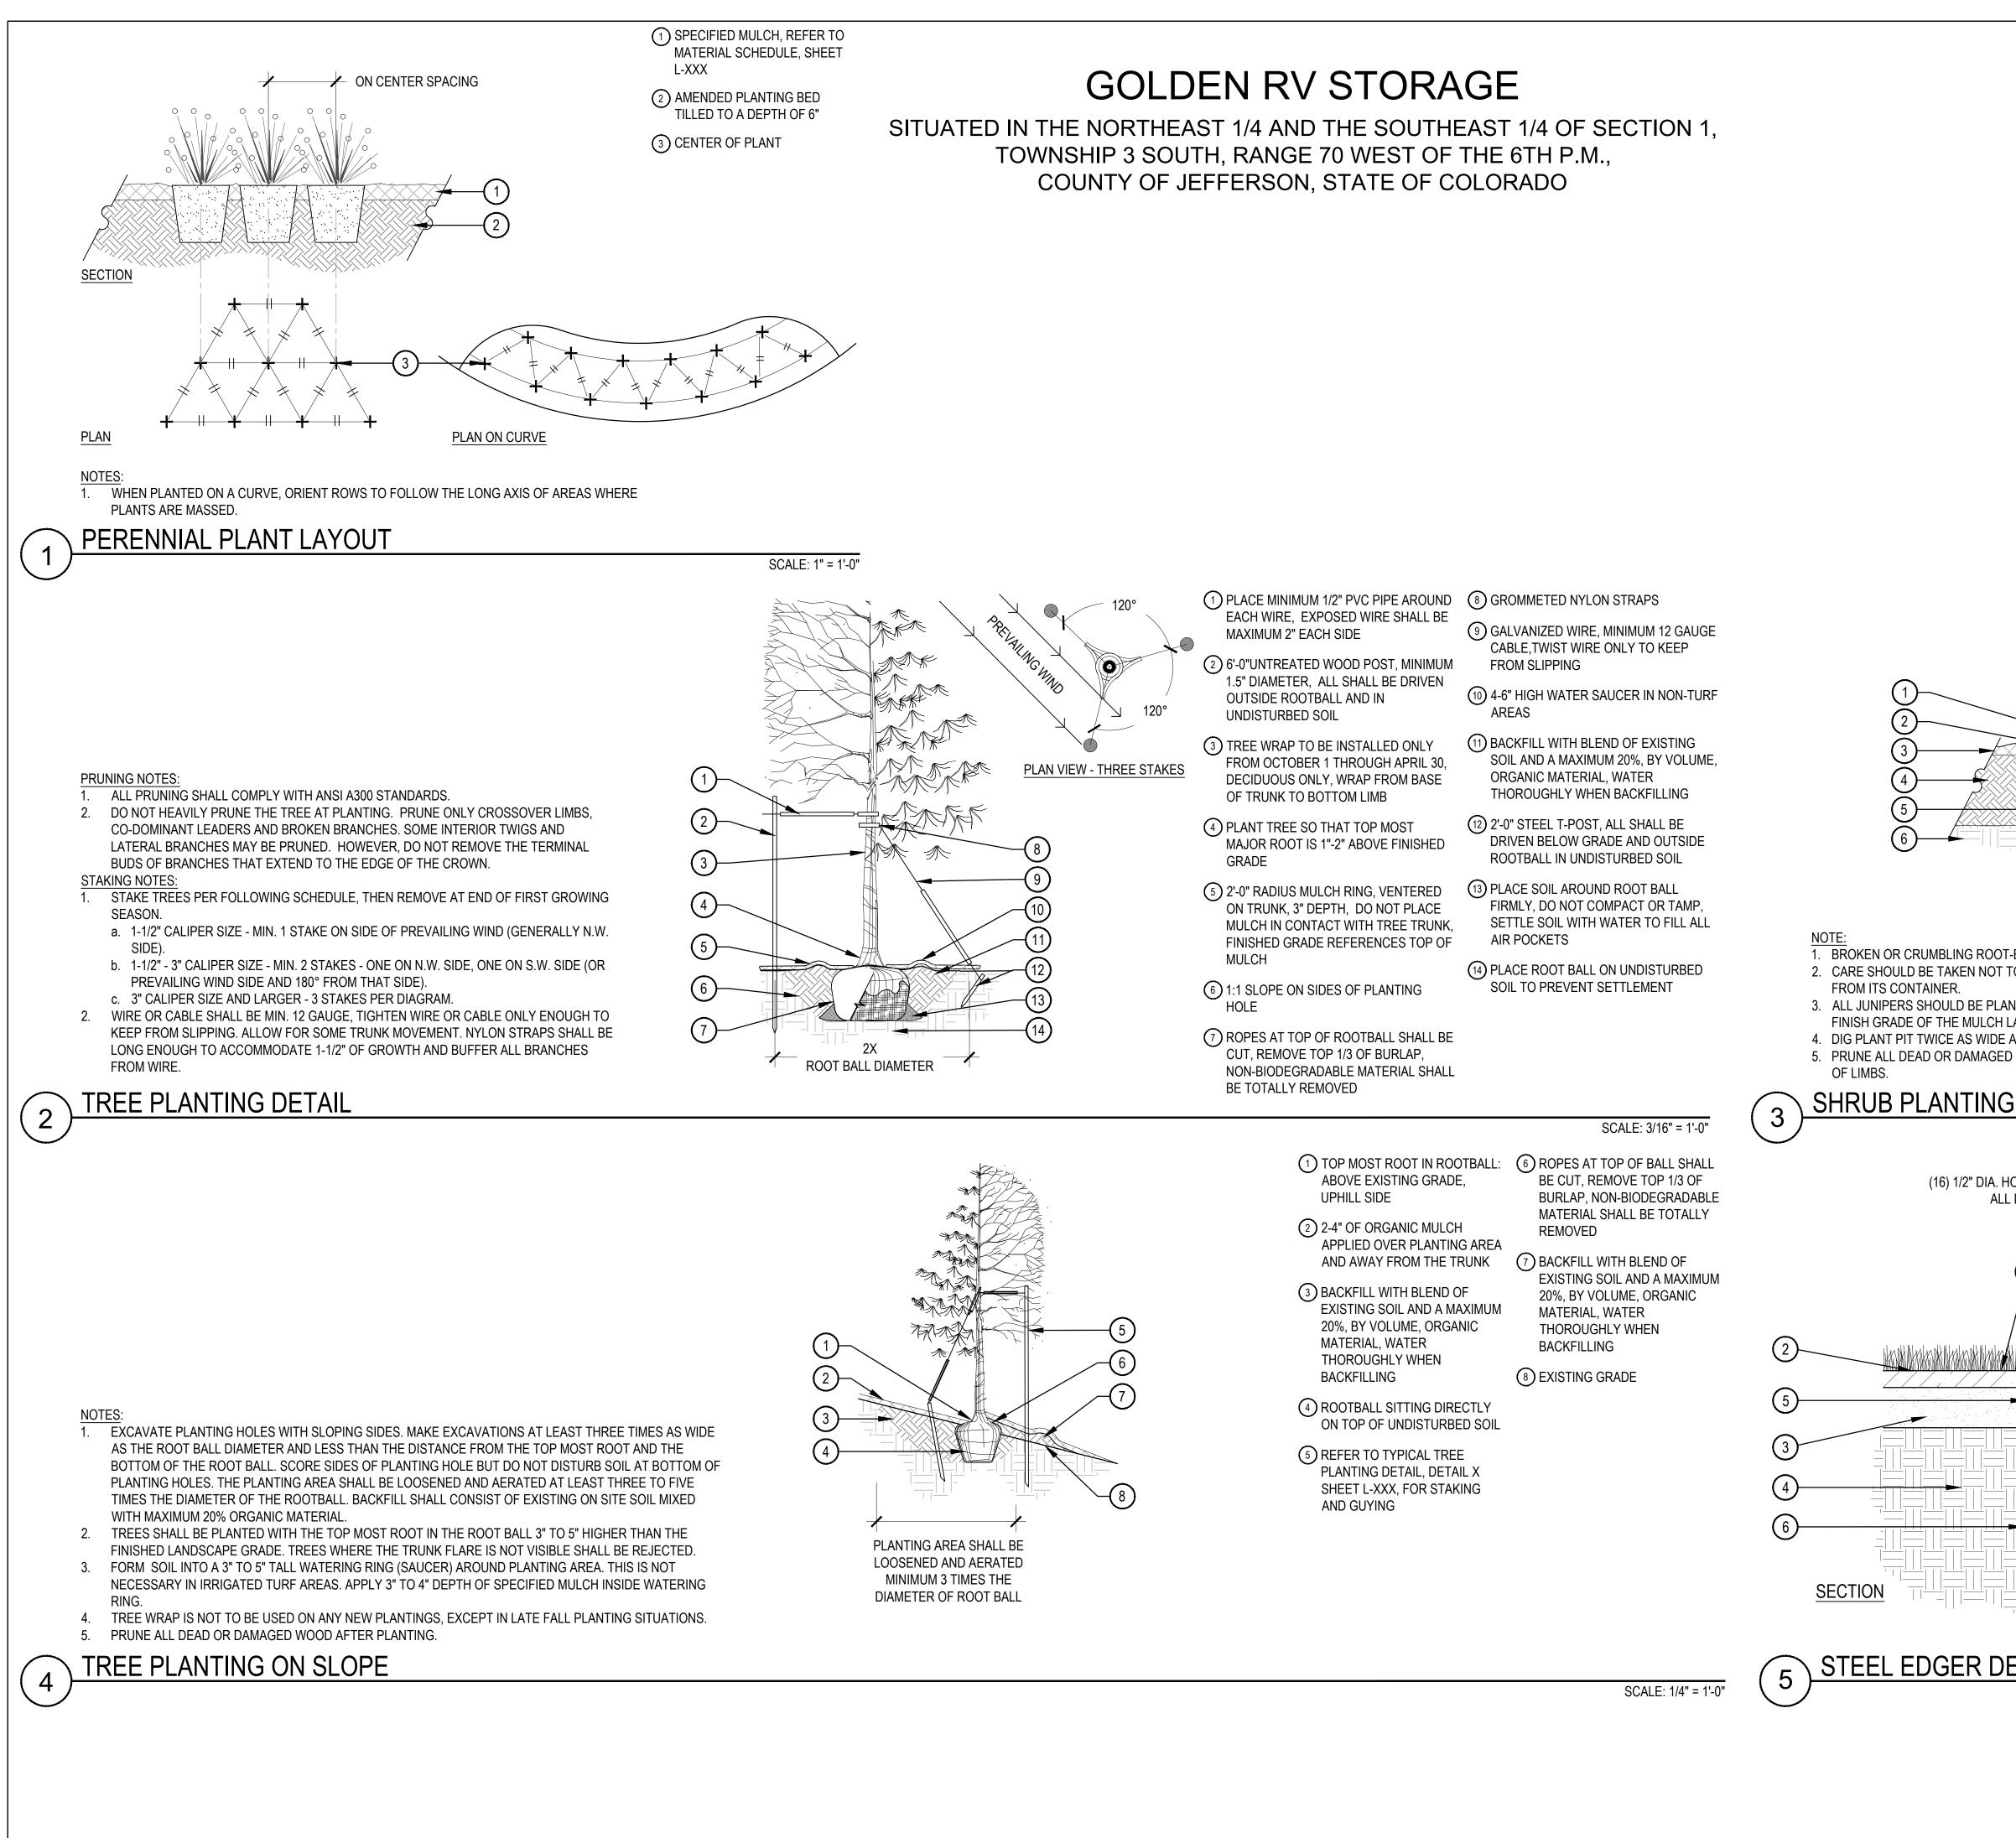



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SHEET TITLE: LANDSCAPE DETAILS

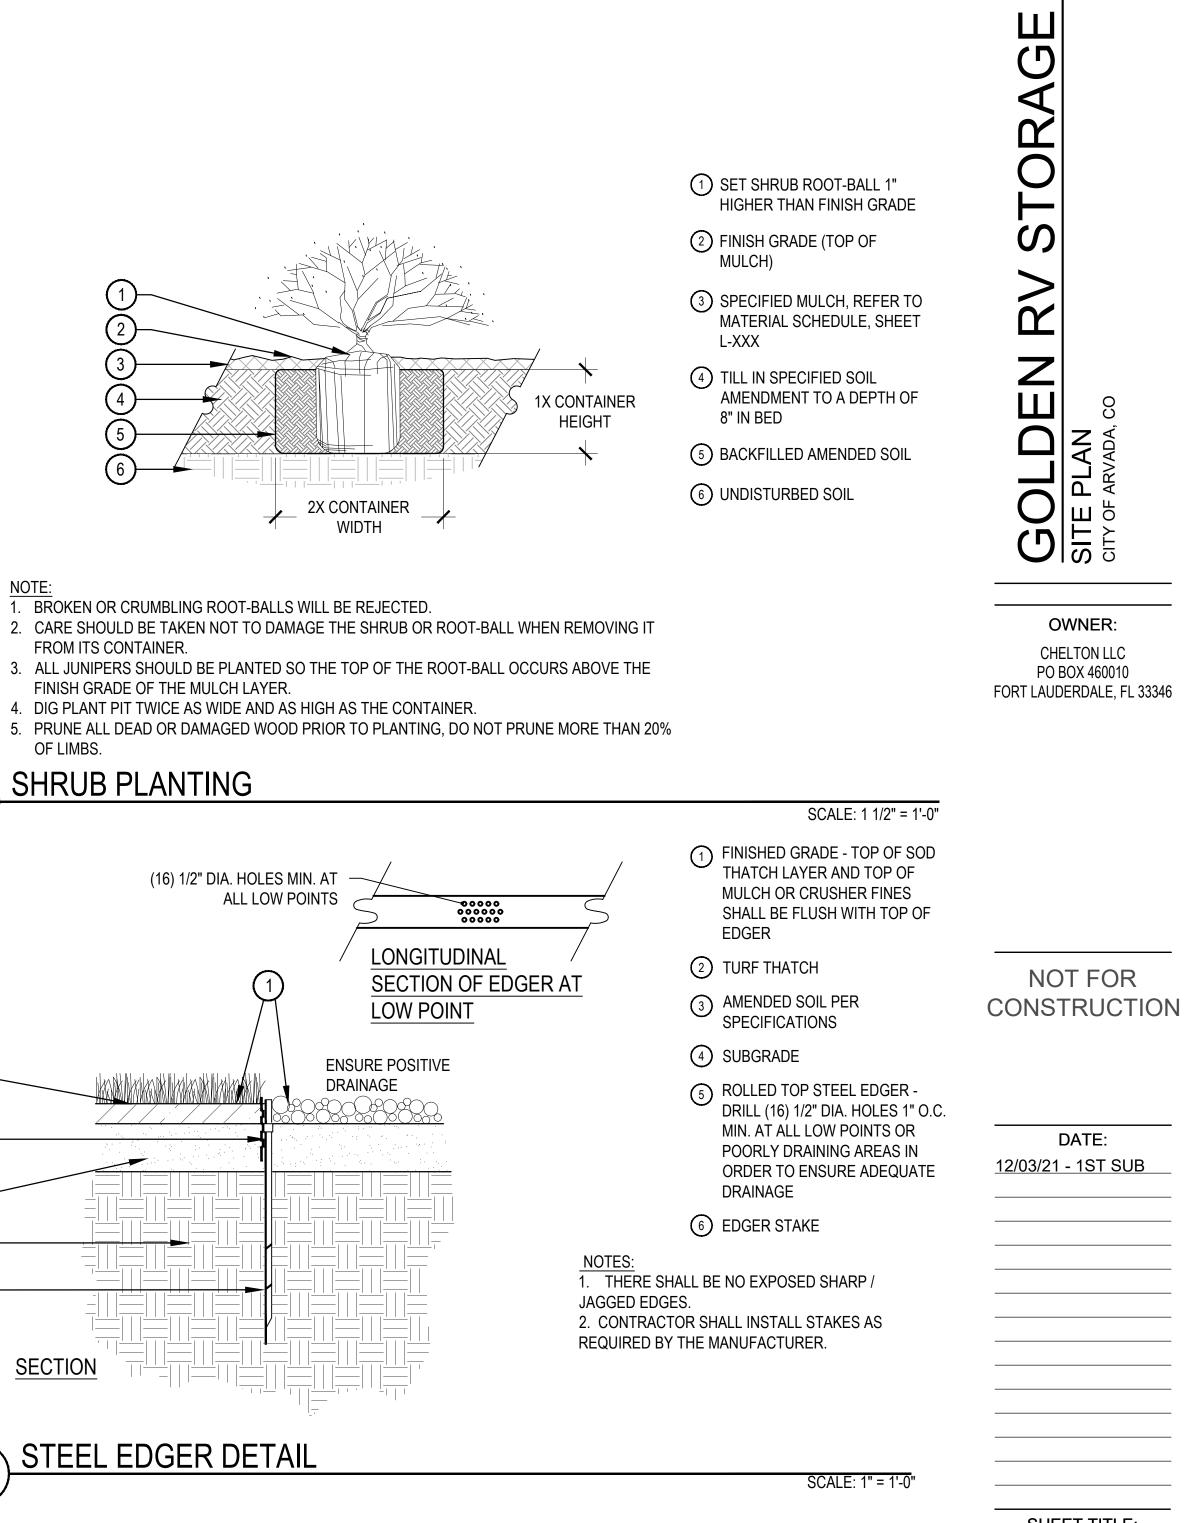SHEET13OF 16

$3 \frac{\text{NORTH ELEVATION}}{3/16'' = 1'-0''}$



1 WEST ELEVATION 3/16" = 1'-0"



GOLDEN RV STORAGE SITUATED IN THE NORTHEAST 1/4 AND THE SOUTHEAST 1/4 OF SECTION 1, TOWNSHIP 3 SOUTH, RANGE 70 WEST OF THE 6TH P.M., COUNTY OF JEFFERSON, STATE OF COLORADO

LOW EAVE

LEVEL 1 100' - 0"




 $2 \frac{\text{SOUTH ELEVATION}}{\frac{3}{16"} = 1' - 0"}$



Key Value

4.1
4.2
5.2
5.5
7.1
7.2
7.8
8.1
8.3
1

8.4 10.12

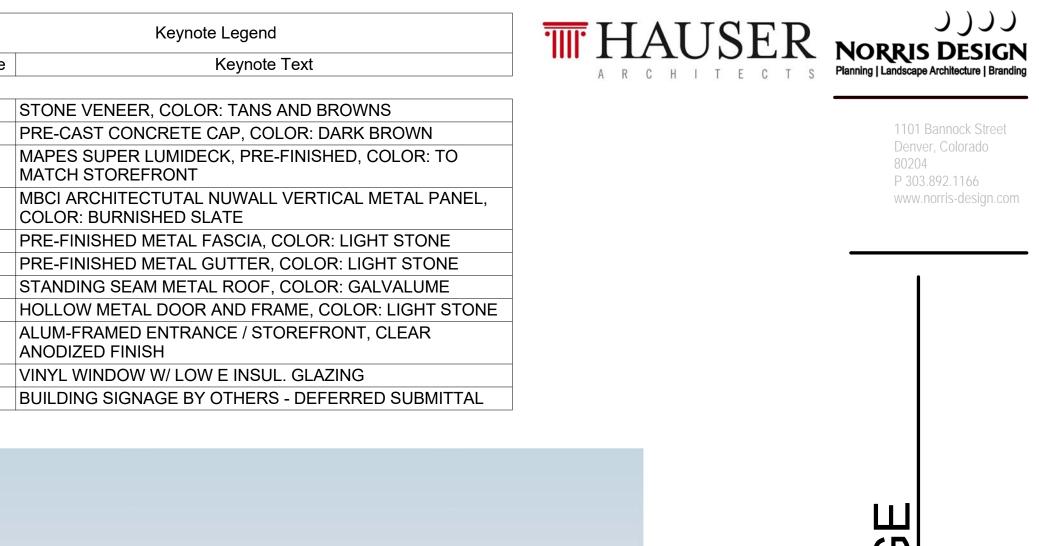

__LEVEL 1 100' - 0" 🗣




OWNER: CHELTON LLC PO BOX 460010 FORT LAUDERDALE, FL 33346

SHEET 14 OF 16



GOLDEN RV STORAGE SITUATED IN THE NORTHEAST 1/4 AND THE SOUTHEAST 1/4 OF SECTION 1, TOWNSHIP 3 SOUTH, RANGE 70 WEST OF THE 6TH P.M., COUNTY OF JEFFERSON, STATE OF COLORADO JRHOOD FILING NO. GEOS NEIGHBORHOOD FILING NO. 1 GEOS NEIGHBORHOOD FILING NO. 1 01 01 01 01 02 02 03 04 07 14 34 43 46 48 43 37 31 27 24 23 25 28 33 36 41 43 40 32 40 43 43 39 37 34 32 32 35 37 40 43 43 39 37 34 32 32 35 37 40 43 43 39 37 34 32 32 35 37 40 43 43 39 37 34 32 32 35 37 40 43 43 39 37 34 32 32 35 37 40 43 43 40 35 30 25 20 18 15 13 11 11 14 17 21 24 27 31 35 36 40 42 42 47 53 54 51 42 32 22 17 14 11 0.8 05 04 01 01 01 02 03 03 05 08 12 21 34 39 39 38 37 36 36 36 38 40 43 47 49 47 41 46 48 46 42 37 34 32 33 36 40 46 50 52 56 51 49 44 37 32 26 21 20 21 26 32 38 45 51 54 60 53 48 42 34 27 21 16 13 13 16 21 28 36 45 52 56 51 49 48 39 32 24 19 17 WP 01 01 01 01 01 01 02 02 02 02 03 06 21 36 40 41 41 43 43 42 39 37 36 34 28 16 23 29 29 27 27 27 28 28 28 29 30 29 21 27 29 28 26 24 22 20 19 21 25 32 38 46 52 57 64 55 49 43 35 28 21 16 13 13 15 20 27 33 39 45 48 56 49 47 40 34 28 22 25 62 01 01 01 01 01 02 02 02 04 07 19 36 45 49 50 48 44 39 35 32 29 23 16 17 21 20 19 20 21 22 22 21 21 22 22 21 21 22 20 17 18 18 17 18 19 23 27 30 33 35 34 33 35 34 33 35 34 33 35 34 31 29 24 19 14 12 12 14 18 22 25 28 31 31 30 32 31 28 26 23 18 15 11 05 03 04 06 02 01 00 00 04 08 12 18 35 46 48 49 44 36 29 24 20 20 21 25 32 38 45 52 58 65 55 48 41 34 27 21 17 15 15 15 15 15 15 15 15 15 15 15 15 14 14 13 11 10 10 10 11 12 12 13 12 11 10 10 10 12 12 12 12 11 10 09 07 05 03 02 01 01 01 01 01 00 00 01 01 01 01 01 01 02 02 03 03 04 06 07 15 25 25 23 20 19 20 22 26 29 32 33 36 36 37 36 34 31 28 24 20 17 17 20 24 30 35 40 43 42 41 42 42 37 32 27 20 16 13 13 16 20 26 30 33 36 35 29 34 36 35 31 28 22 16 10 07 04 07 04 0.1 0.1 0.1 0.1 0.2 0.4 08 10 11 11 1.1 1.1 1.4 1.6 1.8 1.8 1.9 20 2.0 2.1 2.0 1.9 1.7 1.6 1.6 1.5 1.5 1.6 1.9 2.5 3.3 4.2 4.9 5.2 6.0 6.8 5.5 5.0 4.6 3.7 2.9 2.1 1.6 1.4 1.4 1.7 2.2 2.9 3.8 4.7 5.0 5.0 4.9 4.2 3.3 2.4 1.7 1.1 0.7 0.4 0.2 0.1 1.1 0.0 0.0 0.0 . .0.1 .0.1 .0.1 .0.1 0.1 02 04 05 06 08 09 10 14 11 11 11 11 11 11 10 10 10 10 10 10 11 12 14 17 23 29 33 38 40 39 38 39 40 35 31 26 20 15 13 13 16 21 27 33 40 45 45 44 45 45 42 36 30 23 16 11 07 04 02 01 01 00 00 00 05 06 07 08 08 08 08 08 07 0.7 0.7 0.7 0.7 0.8 08 0.8 0.9 1.0 1.3 1.6 2.1 2.6 2.8 3.1 3.3 3.0 2.6 3.3 3.2 3.0 2.7 2.3 1.8 1.4 1.2 1.2 1.5 2.0 2.5 3.0 3.3 3.6 3.5 2.9 3.3 3.6 3.5 3.1 2.7 2.2 1.5 1.0 0.6 0.4 0.2 0.1 00 00 00 00 01 01 01 02 02 03 05 05 06 06 06 06 06 05 05 05 05 05 05 06 06 06 0.0 0.0 0.1 1.1.5 1.9 22 2.4 2.6 2.8 2.5 2.1 2.7 2.8 2.5 2.3 2.0 1.6 1.3 1.1 1.2 1.4 1.8 2.2 2.5 2.8 30 3.0 2.1 2.6 3.0 2.9 2.6 2.4 1.9 1.4 1.0 0.6 0.3 0.2 0.1 0.1 0.0 0.0 0.0

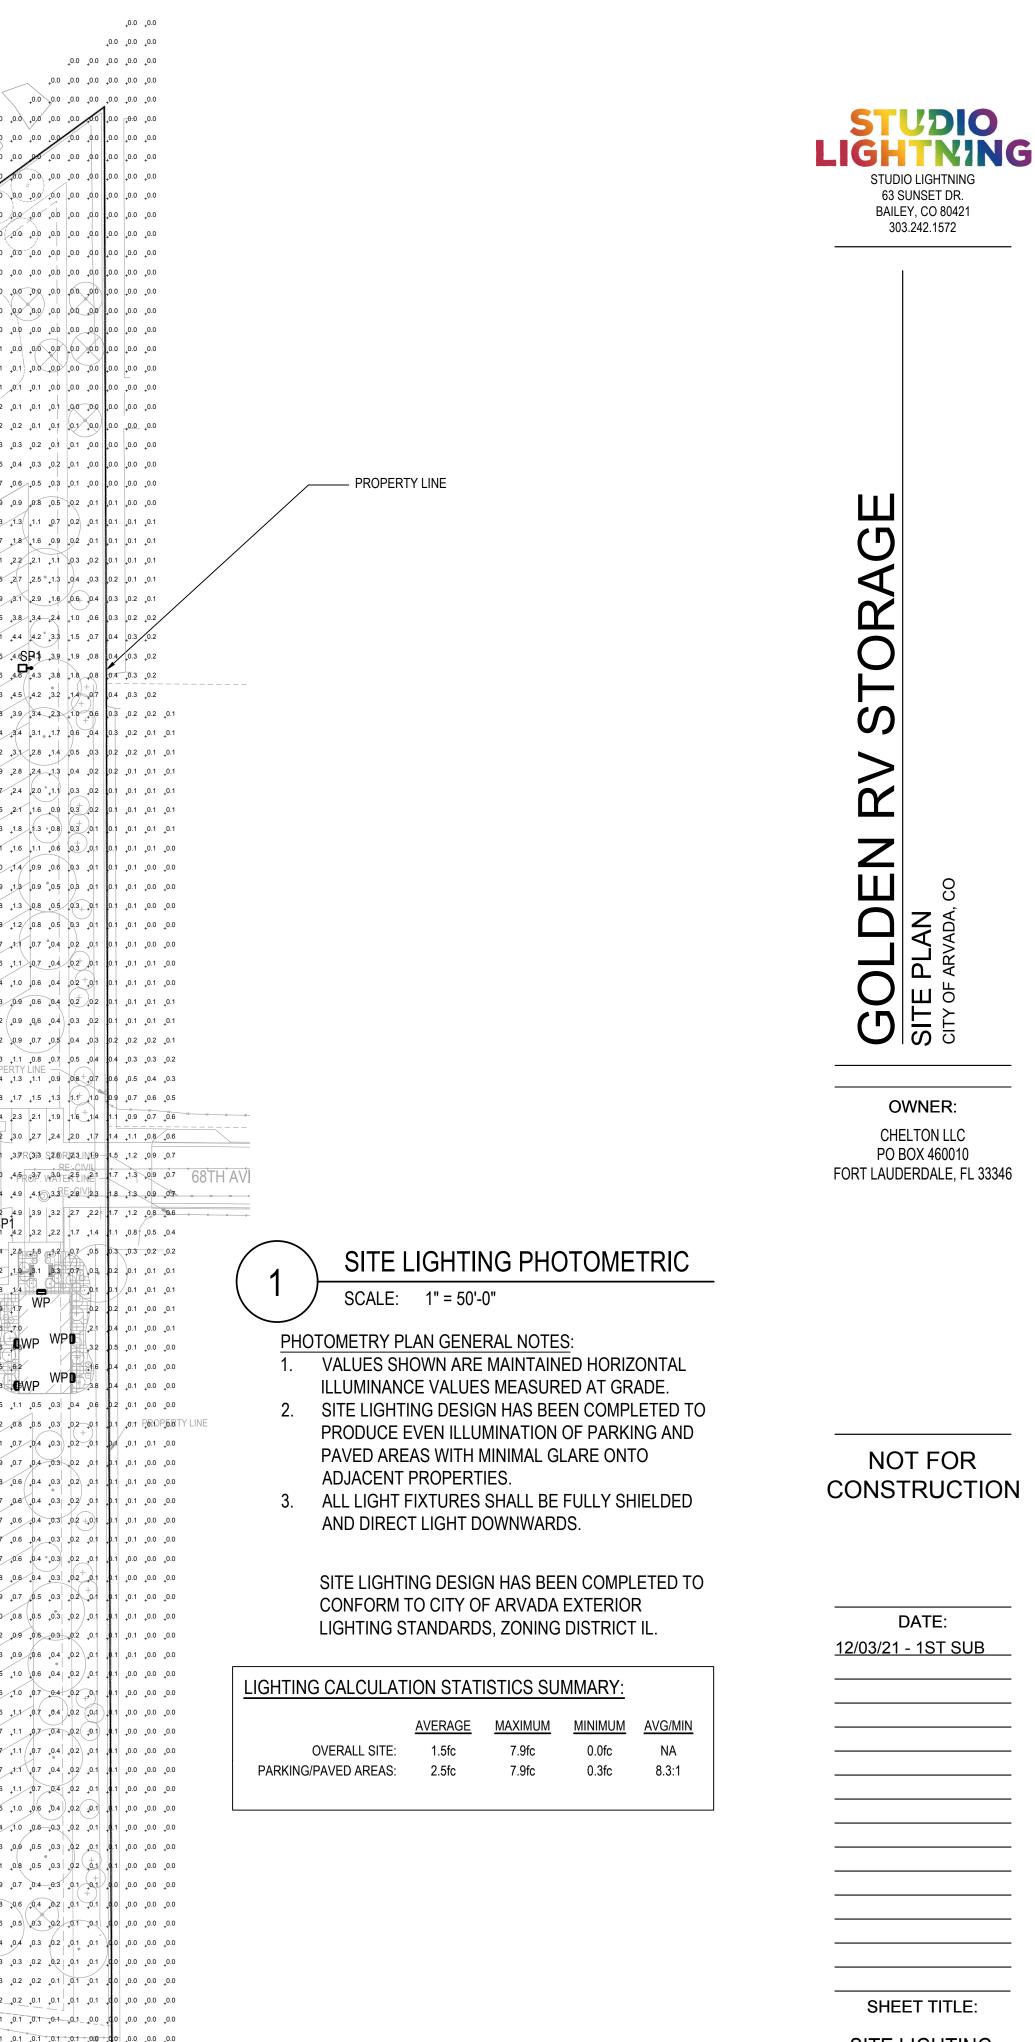

SITE LIGHTING PHOTOMETRIC

15 SHEET 15 OF 16

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SITUATED IN THE NORTHEAST 1/4 AND THE SOUTHEAST 1/4 OF SECTION 1, TOWNSHIP 3 SOUTH, RANGE 70 WEST OF THE 6TH P.M., COUNTY OF JEFFERSON, STATE OF COLORADO

GOLDEN RV STORAGE

Symbol	Label	General Description	Mounting Height	Color	Catalog Number	Lamp	LLF	Watts	Lumens	Shielding	Keyed Notes
_		SITE POLE	35'-0" AFG	BLACK	MCGRAW-EDISON	LED	1.00	333W	42,313	FULL CUT-OFF	1
Ļ	SP1	PARKING & DRIVES			GLEON-SA6-C-730-U-T3- BK-AHDXXX						
		SITE POLE	35'-0" AFG	BLACK	MCGRAW-EDISON	LED	1.00	(2)333W	(2)42,313	FULL CUT-OFF	1
Ţ	SP2	PARKING & DRIVES			GLEON-SA6-C-730-U-T3- BK-AHDXXX-MA-1039						
8	WP	WALL PACK	8'-0" AFG	BLACK	LUMARK	LED	1.00	12W	1418	FULL CUT-OFF	1
		STORAGE OFFICE			XTOR1B-Y-BK						

DIMMING APPROACH IS UTILIZED, THE E.C. SHALL PROVIDE ALL NECESSARY CONTROLS TO PROVIDE A COMPLETE OPERATING SYSTEM. CURRENTLY, THE LIGHTING DESIGNER HAS SPECIFIED AN AFTER HOURS DIMMING FEATURE FOR FIXTURE TYPE SP1 AND SP2, AS NOTED IN THE CATALOG NUMBER. THE 'XXX' PORTION OF THE CATALOG NUMBER FOLLOWING 'AHD' WILL NEED TO BE COMPLETED ONCE THE TOTAL AFTER HOURS TIME LENGTH IS KNOWN.







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NOT FOR CONSTRUCTION

DATE: <u>12/03/21 - 1ST SUB</u>

SHEET TITLE: SITE LIGHTING DETAILS 16 SHEET 16 OF 16